

DURRELL DESIGN GROUP, PLLC

500-G E. WOODROW WILSON AVENUE JACKSON, MISSISSIPPI 39216

PHONE: 601.708.4788 FAX: 601.398.3960

ADDENDUM NUMBER TWO (2)

2018 BOND PROJECT: RESTROOM IMPROVEMENTS FOR JIM HILL HIGH SCHOOL

JACKSON PUBLIC SCHOOL DISTRICT JACKSON, MISSISSIPPI

January 16, 2020

TITLE SHEET	1
ADDENDUM	3
ATTACHMENTS	33
TOTAL NUMBER OF PAGES	37



THIS ADDENDUM, WHICH CONTAINS REVISIONS TO THE WORK CONTAINED IN THE ORIGINAL DRAWINGS AND SPECIFICATIONS DATED DECEMBER 02, 2019 SHALL BECOME A PART OF SUCH DRAWINGS AND SPECIFICATIONS AS IF BOUND THEREIN, OTHER REQUIREMENTS OF DRAWINGS AND SPECIFICATIONS RELATING TO ITEMS INVOLVED SHALL REMAIN AS SPECIFIED.

THE ABOVE NAMED CONTRACT DOCUMENTS ARE HEREBY MODIFIED, CORRECTED AND/OR SUPPLEMENTED BY THIS ADDENDUM AS FOLLOWS:

FOR INFORMATION ONLY

1. The Bid Opening is at 2pm on January 21, 2020 at the Business Office of the Jackson Public School District, 662 South President Street, Jackson, Mississippi, 39201.

PERTAINING TO THE SPECIFICATIONS:

Item 1: TABLE OF CONTENTS - APPENDIX

ADD Attached Owner provided report – Jim High School Sewer Inspection Report.

Item 2: SECTION 003000 - PROPOSAL FORM

<u>DELETE</u> Section in its entirety and **<u>REPLACE</u>** with Attached Section 003000 – Proposal Form.

Item 3: SECTION 011000 – SUMMARY OF WORK

- Paragraph 1.03 Description of Work. **DELETE** Items 1 and 2 in its entirety and **REPLACE** with the following:
 - 1. Field Verification and visual inspection of existing project conditions;
 - 2. Scope of Work (See plans and specifications for additional information) a. Selective Demolition of Existing Walls, Finishes Fixtures and the provision of new work that includes, but may not be limited to, new walls, finishes with plumbing and electrical improvements.
- 2. Paragraph 1.06.A.1.c. Critical work Sequence. **DELETE** items "a through e" in its entirety and REPLACE with the following:
 - a. Notice to Proceed April 1, 2020
 - July 17, 2020 b. Substantial Completion
 - c. Phasing of Work. It is the Owner's intent to have all base bid work as first priority, assuming alternate scopes are approved. All work related to Alternates, Section 012300, should be completed once first priority items are completed. Contractor to provide an action plan that highlights project execution and performance approach for Architect's and Owner review

Item 4: SECTION 012100 - ALLOWANCES

In paragraph 1.04 Allowance Schedule, **ADD** the following:

"B. Janitorial Allowance: Include the stipulated sum/price of \$12,000.00 for the use or Additional hours for the district's custodial staff."

Item 5: SECTION 012300 - ALTERNATES

<u>DELETE</u> Section in its entirety and **<u>REPLACE</u>** with Attached Section 012300 – Alternates.

Item 6: SECTION 015000 - TEMPORARY FACILITIES AND CONTROLS

Page 2 of 4

CLARIFICATION. JPS will provide water and electrical at no charge, within reason, as long as the Contractor conveys said water and power from the outlet to the point of use. Power other than normal line voltage must be provided by the Contractor's generator.

Item 7: SECTION 096700 - RESINOUS FLOORING

<u>DELETE</u> Section in its entirety and <u>**REPLACE**</u> with Attached Section 096700 – Resinous Flooring.

Item 8: SECTION 10800 - TOILET ACCESSORIES

In paragraph 2.05A

- 1. **DELETE** wording that reads as "B-2730" and **REPLACE** with "B-2740".
- 2. **DELETE** wording that reads as "B-818615" and **REPLACE** with "B-2112".
- 3. **DELETE** wording that reads as "B-2620" and **REPLACE** with "B-262".

PERTAINING TO THE DRAWINGS:

ARCHITECTURAL

Item 9: SHEET T101 – TITLE SHEET

- 1. <u>ADD</u> attached Drawing A108- RENOVATION ENLARGED PLANS TOILETS (ALTERNATE 4).
- 2. ADD attached Drawing A109- INTERIOR ELEVATION (ALTERNATE 4).

Item 10: SHEET R101 - FLOORPLAN - EXISTING

DELETE Drawing R101 in its entirety and **REPLACE** with attached R101R.

Item 11: SHEET R102 – FLOORPLAN- EXISTING

DELETE Drawing R102 in its entirety and **REPLACE** with attached R102R.

Item 12: SHEET D101 – DEMOLITION PLANS - TOILETS

DELETE Drawing D101 in its entirety and **REPLACE** with attached D101R.

Item 13: SHEET A101 – MASTER FLOOR PLAN FIRST FLOOR- NEW WORK

DELETE Drawing A101 in its entirety and **REPLACE** with attached A101R.

Item 14: SHEET A102 - MASTER FLOOR PLAN SECOND FLOOR- NEW WORK

DELETE Drawing A102 in its entirety and **REPLACE** with attached A102R.

Item 15: SHEET A103 – RENOVATION ENLARGED PLANS TOILETS

DELETE Drawing A103 in its entirety and **REPLACE** with attached A103R.

Item 16: SHEET A104 – REFLECTED CEILING PLANS

DELETE Drawing A104 in its entirety and **REPLACE** with attached A104R.

Item 17: SHEET A105 – INTERIOR ELEVATIONS

DELETE Drawing A105 in its entirety and **REPLACE** with attached A105R.

Item 18: SHEET A106 – INTERIOR ELEVATIONS

<u>DELETE</u> Drawing A106 in its entirety and <u>**REPLACE**</u> with attached A106R.

Item 19: SHEET A107 – INTERIOR ELEVATIONS

DELETE Drawing A107 in its entirety and **REPLACE** with attached A107R.

Addendum No. 2
2018 Bond Project: Restroom Improvements for Jim Hill High School
Jackson Public School District

DDG Project No.: 19.002

PLUMBING

- Item 20: SHEET P101 FIRST FLOOR PLAN TOILET RENOVATIONS
 - **<u>DELETE</u>** Drawing P101 in its entirety and **<u>REPLACE</u>** with attached P101R.
- Item 21: SHEET P102 SECOND FLOOR PLAN TOILET RENOVATIONS
 - **<u>DELETE</u>** Drawing P102 in its entirety and **<u>REPLACE</u>** with attached P102R.
- Item 22: SHEET P103 LARGE SCALE PLANS TOILET RENOVATIONS
 - **<u>DELETE</u>** Drawing P103 in its entirety and <u>**REPLACE**</u> with attached P103R.
- Item 23: SHEET P104 PLUMBING FIXTURE AND DETAILS FOR TOILET RENOVATION DELETE Drawing P104 in its entirety and REPLACE with attached P104R.

ELECTRICAL

- Item 24: SHEET E101 ELECTRICAL SYMBOLS, LIGHTING SCHEDULE
 - **DELETE** Drawing E101 in its entirety and **REPLACE** with attached E101R.
- Item 25: SHEET E201 OVERALL FIRST AND SECOND FLOOR LOCATION PLANS
 - **<u>DELETE</u>** Drawing E201 in its entirety and <u>**REPLACE**</u> with attached E201R.
- Item 26: SHEET E202 ELECTRICAL FLOOR PLANS
 - **<u>DELETE</u>** Drawing E202 in its entirety and <u>**REPLACE**</u> with attached E202R.

END OF ADDENDUM ITEMS

BUFORD PLUMBING COMPANY, INC.

MECHANICAL CONTRACTORS

P.O. BOX 8601 JACKSON, MISSISSIPPI 39284-8601

(601) 372-7676 Fax 373-4014

13 September, 2019

Re: Jim Hill High School Sewer Inspection Report

General Observations

- 1. All Water Closet Carriers in many cases are rusted beyond refurbishment
- 2. All steel nipples and lavatory arms in wall will need to be replaced
- 3. All Sanitary Waste and Vent Piping in building and within crawlspace is cast iron, all exterior sewer piping appears to be PVC.
- 4. All floor drains and associated P-traps serving the toilet areas are either inoperable or leaking.
- 5. There are very few cleanouts in the sanitary sewer system. New 2-way Cleanouts need to be installed on all sewer lines as they exit the building.
- 6. There are only two crawlspace access openings one at the auditorium, and one in the floor under the stairwell across from restroom area 1. Additional openings need to be made to do piping work.
- 7. The only other cleanout we found outside has a Gatorade bottle in it. I am going to send our men back out to try to get it out and inspect where it goes.

Toilet Area 1

- 1. Plumbing piping in crawl space serving the restrooms is intact, except for floor drains and p-traps.
- 2. The 4" and 6" Cast Iron sewer trunk lines from restroom area to exterior of building is intact.
- 3. There is a sink hole at the North end of the building where the sewer exits. The sewer trunk line is most probably broken at this point, because the camera cable would not go any further.

Toilet Area 2

- 1. Plumbing piping in crawl space serving the restrooms is intact, except for floor drains and p-traps.
- 2. The 4" and 6" Cast Iron sewer trunk lines from restroom area to exterior of building is intact.

Toilet Area 3

- 1. All Sanitary sewer piping in crawlspace needs to be replaced. It is highly corroded, been patched on, and is leaking.
- 2. All Sanitary sewer piping serving upstairs restrooms needs to be repaired or replaced. It is heavily corroded.
- 3. Steel Heating and Chilled water piping in this area is lacking insulation and is heavily corroded.

Toilet Area 4


- 1. Plumbing piping in crawl space serving the restrooms is intact, except for floor drains and p-traps.
- 2. The 4" Cast Iron sewer trunk lines from restroom area to exterior of building is intact.

Toilet Area 5

- 1. Plumbing piping in crawl space serving the restrooms is intact, except for floor drains and p-traps. P-trap in boys restroom is rotted and stopped up.
- 2. The 4" Cast Iron sewer trunk lines from restroom area to exterior of building is intact.

Toilet Area 6

1. No crawlspace access to this location. May be a slab on grade. FYI: The people on site said they want a washroom at this location.

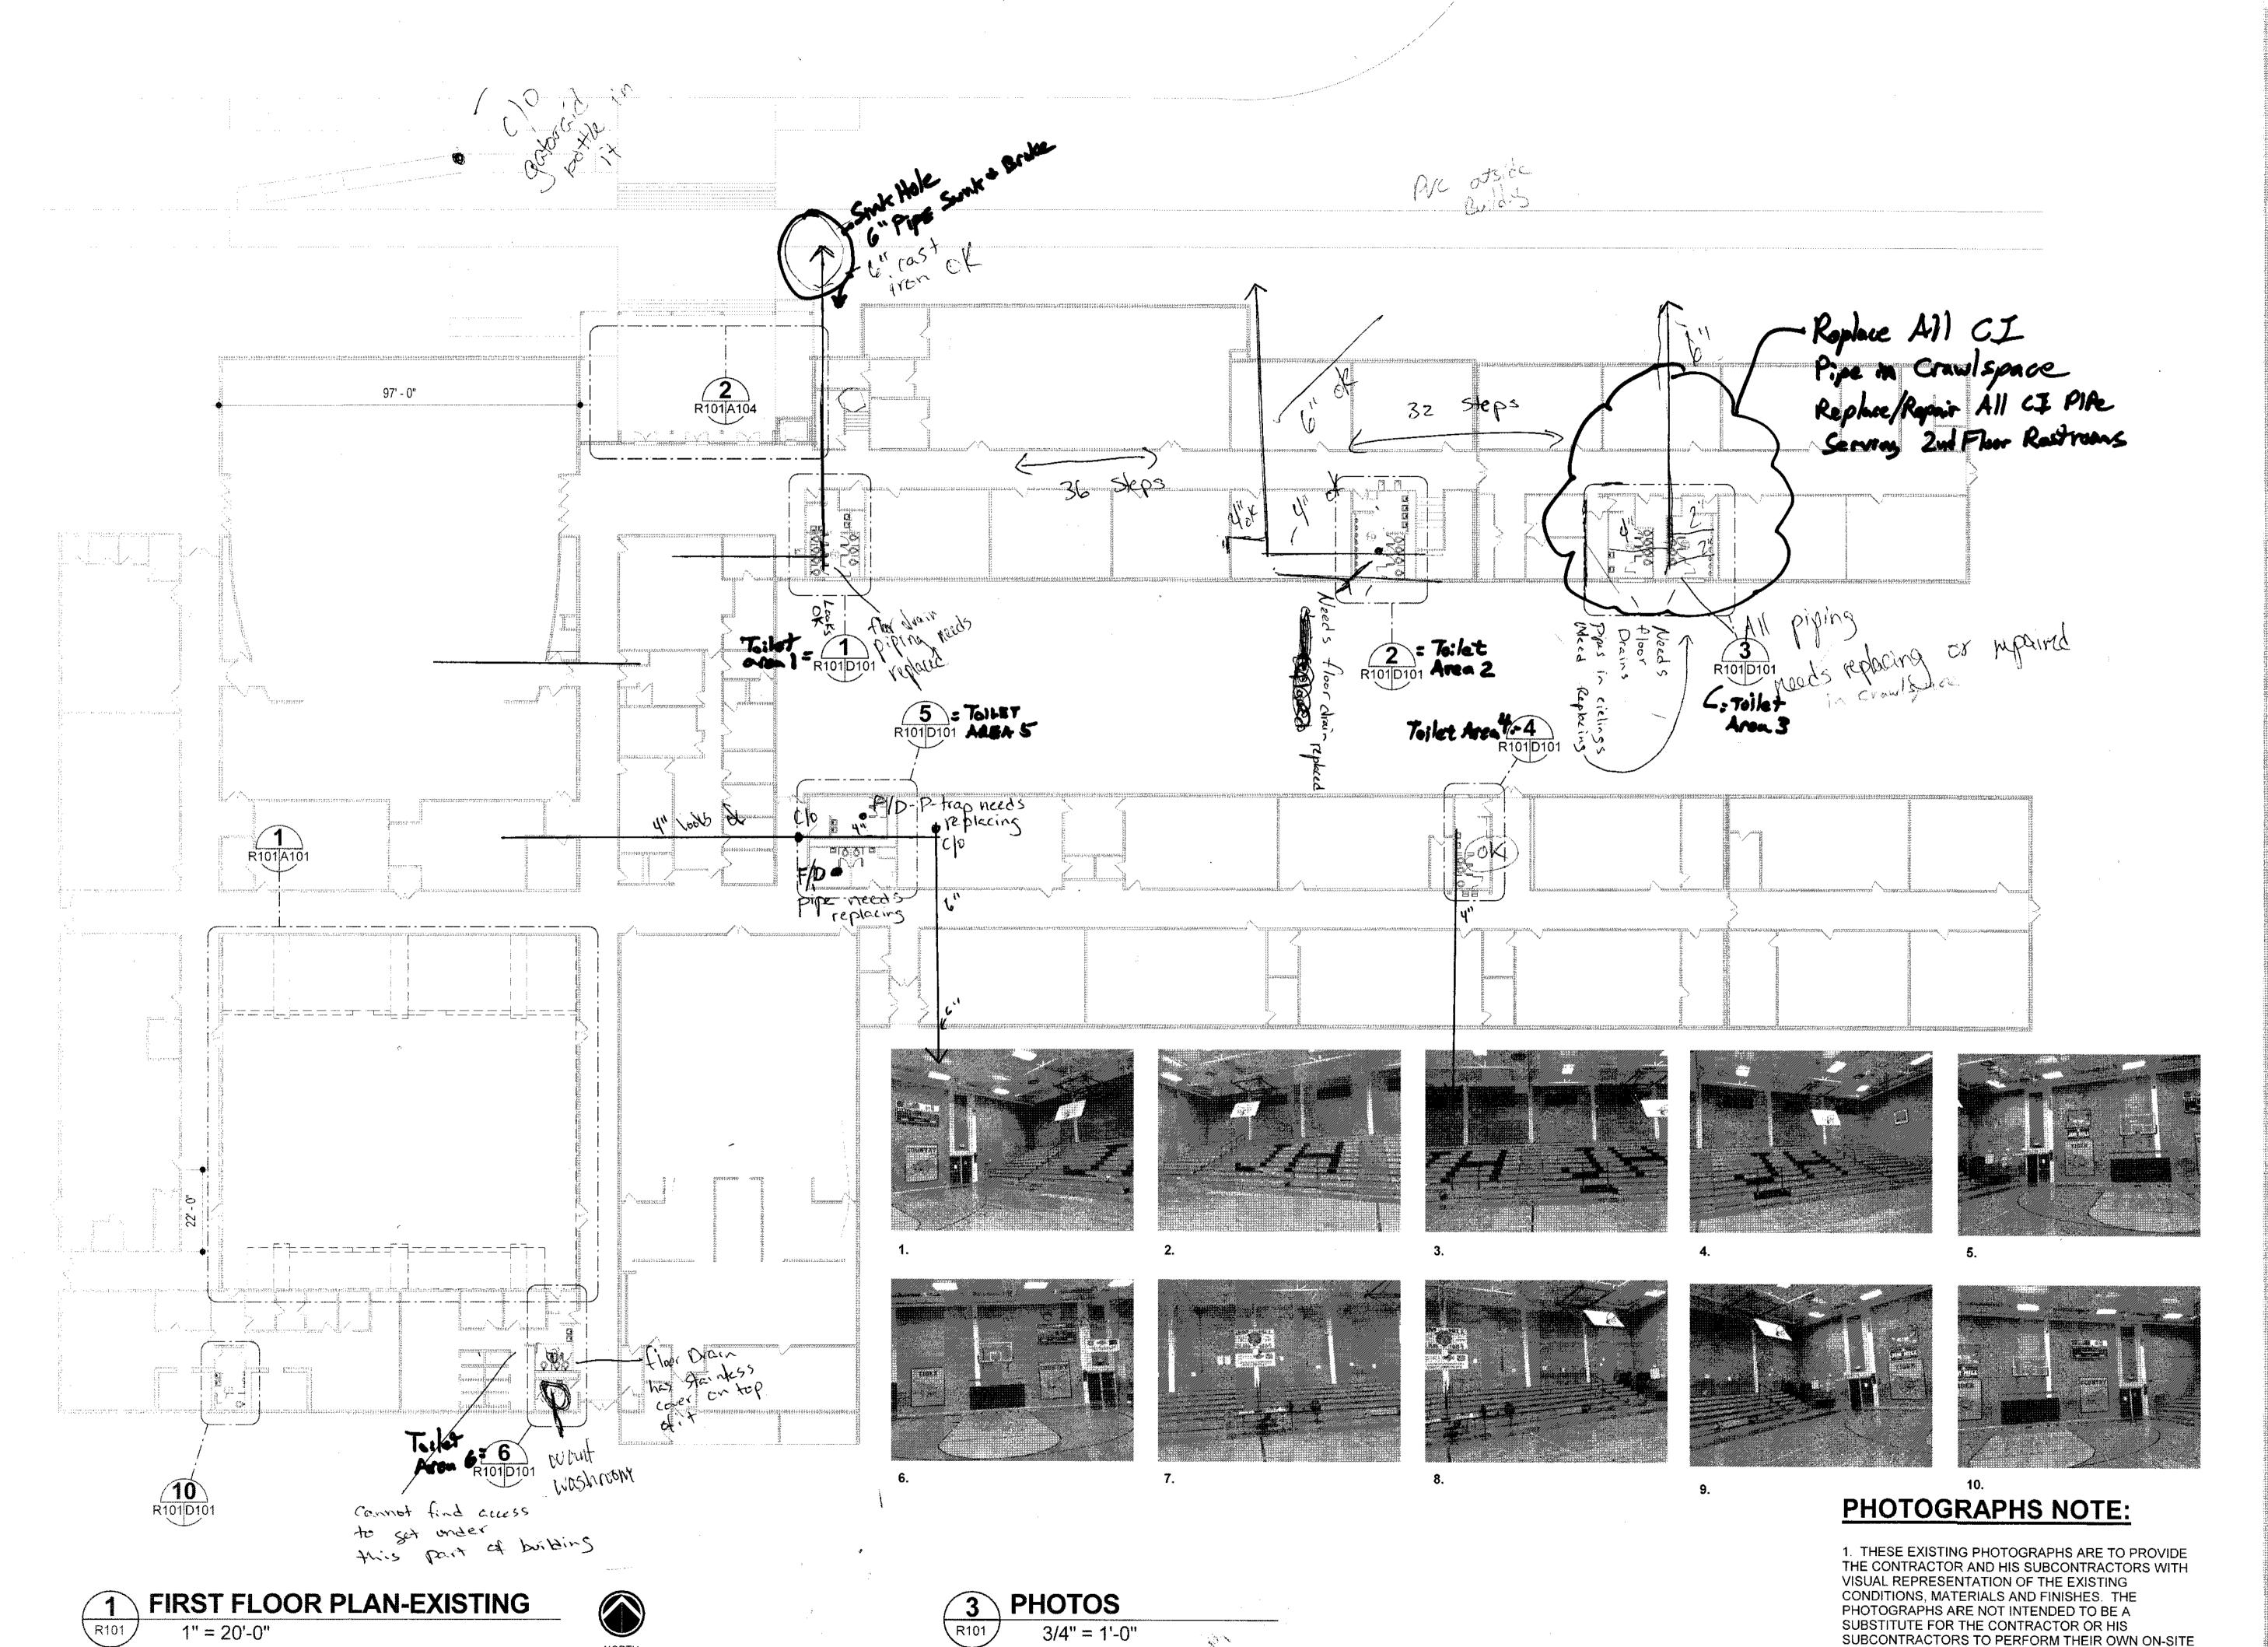

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NOT FOR TON ONSTRUCTION

SCHOOL IMPROVEMENTS

2018 BOND PROJECT JIM HILL HIGH STACKSON, MS 39202

Project 19.002 Number: 08.19.2019

Drawn by: _____

Revisions

3 Sheet Title

FLOOR PLAN -EXISTING

Sheet Number 2 of

R101

REVIEW OF THE EXISTING CONDITIONS PRIOR TO

BIDDING THE PROJECT.

SECTION 003000

PROPOSAL FORM

Date:		
То:	Board of Trustees, Jackson Public School District, Jackson, Miss	issippi
RE:	2018 BOND PROJECT FOR JIM HILL HIGH SCHOOL: REST	ГКООМ
(the "Project"	IMPROVEMENTS PROJECT ")	
Prepared by:	Durrell Design Group, PLLC, 500-G E. Woodrow Wilson Aver MS 39216; Greg L. Durrell, AIA - Principal	nue, Jackson,
Ladies and Go	entlemen:	
opening date, affecting the deemed necessand all supple hereinbelow. opening. If we five (45) days within ten (1 documentatio award of this notice of accordingly which was a supplementation of accordingly which which which which which which which was a supplementation of according to the which which was a supplementation of according to the which was a supplementation of the which was a supplementatio	carefully examined the bid specifications and all addenda issued proposed, having visited the Project site and apprised myself/ourselves of the work to be performed, and having obtained and correlated any other start by me/us to submit this bid, hereby propose to furnish all services, materials and equipment required to complete the work at the I/We will not withdraw this bid for forty-five (45) days from the ritten notice of acceptance of this bid is received by me/us from JPSE after the date of the bid opening, I/we shall submit to the Project 10) working days after receipt of such notice, an executed contract on required by the bid specifications. I/We understand and agree the less bid to me/us by the District's Board of Trustees nor receipt be the shall be conditioned upon the execution by BOTH JPSD and the AGREEMENT	the conditions or information oces and labor, cost indicated the date of bid of within forty-Administrator, and all other the coy me/us of a cen JPSD and
Respectfully	submitted,	
CONTRACT	OR NAME:	
ADDRESS: _		
PHONE NUM	MBER:	
SIGNATURE	3:	
PRINT NAM	E:	

TITLE:

DATE:						
CONTRACTOR'S	CERTIFICATE O	OF RESPO	NSIBILITY	NUMBER,	IF	REQUIRED
CONTRACTOR'S	LICENSE NUMBEI	R AND EXF	PIRATION D	OATE		
SURETY NAME .	AND ADDRESS:					
	ndicate the address to nunications relative to					oceed and al
Address if mailed :	:					
Address if Hand-I	Delivered:					
company, etc. If	form of business or Contractor is a corpo cile. If Contractor	ration, indic	ate the state	of incorporat	tion.	Also, indicate
Contractor is a:	Resident Contra	actor	Non-	Resident Con	 tracto	or
must submit with i non-resident cont	ntractors: pursuant to ts bid a copy of its re- ractors. Failure to termination of Contr	sident state's submit th	statute perta is information	nining to such on may resu	state'	s treatment of
Please select one o	of these options to help	p us track m	inority contra	actor ownersh	ip.	
Contractor is:	Non-Minority	Minority	Woma	n & Minority		Woman

Indicate i	f Contractor	Has Made C	ood Faith	Efforts to	Obtain N	MBE/WBE Participation	
_	Yes		N	No			
Describe	Efforts to (Obtain MBE	//WBE Par	ticipation	1		
(Attach	Additional F	Pages if Nece	essary)				
Acknow	ledgment of	Receipt of A	Addenda				
from Conshall not the time	ntractor (e.g. only be ackr	, additional nowledged be nowledged by nowledged be nowledged by nowledged be nowledged by nowle	or modifie elow but sh	ed pricing nall be con	informa npleted a	nay require additional information), in which case the add and attached to Contractor's bed during the course of this bed	lenda oid at
	-	Number	YES	NO	(check	yes or no if received)	
	Addendum				Date		
<u> </u>	Addendum				Date		
	Addendum Addendum				Date		
<u> </u>	ACT TIME				Date		
If this Bi Drawings	d is accepte		-		accorda	nce with the Project Manual	and
	_						
BASE BI	D:	Numerical A	.mount: \$				
		Written Amo	ount: \$				

ALTERNATES: See section 012300 for complete description of each alternate

ADD ALTERNATE ONE: Renovation of Restrooms in one story area portion of building designated as Wing 2.
Numerical Amount: \$
Written Amount: \$
ADD ALTERNATE TWO: Renovation of Restrooms in one story area portion of building located behind Gymnasium.
Numerical Amount: \$
Written Amount: \$
ADD ALTERNATE THREE: Provide new tile full-height on all walls as indicated on drawings. A. BASE BID SPACES (Rm 101, Rm 102, Rm 201, Rm 202) Numerical Amount: \$
Written Amount: \$
B. ALTERNATE ONE SPACES (Rm 105, Rm 106, Rm 107) Numerical Amount: \$
Written Amount: \$
ADD ALTERNATE FOUR: Provide new millwork and sinks A. BASE BID SPACES (Rm 101, Rm 102, Rm103, Rm104, Rm 201, Rm 202, Rm 203, Rm 204) Numerical Amount: \$
Written Amount: \$
B. ALTERNATE ONE SPACES (Rm 105, Rm 106) Numerical Amount: \$
Written Amount: \$

END OF PROPOSAL FORM

SECTION 012300

ALTERNATES

PART 1 GENERAL

1.01 SECTION INCLUDES

A. Description of Alternates.

1.02 RELATED REQUIREMENTS

- A. Section 001000 Instruction to Bidders: Instructions for preparation of pricing alternates.
- B. Section 003000 Proposal Form

1.03 ACCEPTANCE OF ALTERNATES

- A. Alternates quoted on Bid Forms will be reviewed and accepted or rejected at Owner's option. Accepted alternates will be identified in the Owner-Contractor Agreement.
- B. Coordinate related work and modify surrounding work to integrate the work of each alternate.

1.04 SCHEDULE OF ALTERNATES

- A. Add Alternate No. 1: Provide all labor and material for the selective demolition and renovation of the restrooms in Wing 2 as indicated on drawings. All work, including plumbing, mechanical and electrical, related to these restrooms will be included in this alternate.
- B Add Alternate No. 2: Provide the labor and material for the selective demolition and renovation of the restrooms located behind the gymnasium as indicated on drawings. All work, including plumbing, mechanical and electrical, related to these restrooms will be included in this alternate.
- C Add Alternate No. 3: Provide all labor and material for the installation of wall tiles on all walls, excluding base bid scope of work. Refer to drawings for locations and heights. Alternate pricing to include a separate breakdown for spaces in base bid (Rm 101, Rm 102, Rm 201, Rm 202) and spaces in alternate No. 1 (Rm 105, Rm 106, Rm 107) scopes of work.
- D Add Alternate No. 4: Provide all labor and material for the installation of alternative millwork design with drop in vanities in lieu of single wall mounted vanities as indicated on drawings. Refer to drawings for additional information. Alternate pricing to include a separate breakdown for spaces in base bid ((Rm 101, Rm 102, Rm103, Rm104, Rm 201, Rm 202, Rm 203, Rm 204) and alternate No. 1 (Rm 105, Rm 106) scopes of work.

PART 2 PRODUCTS - NOT USED

PART 3 EXECUTION - NOT USED

END OF SECTION

SECTION 096700

RESINOUS FLOORING

PART 1 - GENERAL

1.1 RELATED DOCUMENTS

A. Drawings and general provisions of the Contract, including General and Supplementary Conditions and Division 1 Specification Sections, apply to this Section.

1.2 SUMMARY

- A. This section includes the following:
 - 1. Quartz flooring system as shown on the drawings and in schedules.

1.3 SYSTEM DESCRIPTION

- A. The work shall consist of preparation of the substrate, the furnishing and application of an epoxy based multi roller applied flooring system with Q 28 colored quartz aggregate and urethane topcoat. The system shall have the color and texture as specified by the Owner with a nominal thickness of 1/8 inch. It shall be applied to the prepared area(s) as defined in the plans strictly in accordance with the Manufacturer's recommendations.
- B. Cove base (if required) to be applied where noted on plans and per manufacturers standard details unless otherwise noted.

1.4 SUBMITTALS

- A. Product Data: Latest edition of Manufacturer's literature including performance data and installation procedures.
- B. Manufacturer's Safety Data Sheet (SDS) for each product being used.
- C. Samples: A 3 inch square sample of the proposed system. Color, texture, and thickness shall be representative of overall appearance of finished system.
- D. See section 01300 (013000) Administrative Requirements for submittal procedures.

1.5 QUALITY ASSURANCE

- A. The Manufacturer shall have a minimum of 10 years experience in the production, sales, and technical support of epoxy and urethane industrial flooring and related materials.
- B. The Applicator shall have been approved by the flooring system manufacturer in all phases of surface preparation and application of the product specified.
- C. No requests for substitutions shall be considered that would change the generic type of the specified System.
- D. A pre-installation conference shall be held between Applicator, General Contractor and the Owner to review and clarification of this specification, application procedure, quality control, inspection and acceptance criteria and production schedule.

1.6 PRODUCT DELIVERY, STORAGE, AND HANDLING

A. Packing and Shipping

DDG Project No.: 19.003 2018 Bond Project: Lanier High School Jackson Public School District 1. All components of the system shall be delivered to the site in the Manufacturer's packaging, clearly identified with the product type and batch number.

B. Storage and Protection

- 1. Proper storage area must be provided for all components. The area shall be between 60 F and 90 F, dry, out of direct sunlight and in accordance with the Manufacturer's recommendations and relevant health and safety regulations.
- 2. Copies of Safety Data Sheets (SDS) for all components shall be kept on site for review by the Engineer or other personnel.

C. Waste Disposal

1. Dispose all for non-hazardous waste generated during installation of the system.

1.7 PROJECT CONDITIONS

A. Site Requirements

- 1. Application may proceed while air, material and substrate temperatures are between 60 F and 90 F providing the substrate temperature is above the dew point. Outside of this range, the Manufacturer shall be consulted.
- 2. The relative humidity in the specific location of the application shall be less than 85 % and the surface temperature shall be at least 5 F above the dew point.
- 3. Provide adequate ventilation for the work area.
- 4. Provide adequate lighting equal to the final lighting level during the preparation and installation of the system.
- B. Conditions of new concrete to be coated with epoxy material.
 - 1. Concrete shall be moisture cured for a minimum of 7 days and have fully cured a minimum of twenty eight days in accordance with ACI-308 prior to the application of the coating system pending moisture tests.
 - 2. Concrete shall have a flat rubbed finish, float or light steel trowel finish (a hard steel trowel finish is neither necessary or desirable).
 - 3. Sealers and curing agents should not to be used.
 - 4. Concrete surfaces on grade shall have been constructed with a vapor barrier to protect against the effects of vapor transmission and possible delamination of the system.

C. Safety Requirements

- 1. All open flames and spark-producing equipment shall be removed from the work area prior to commencement of application.
- 2. "No Smoking" signs shall be posted at the entrances to the work area.
- 3. The Owner shall be responsible for the removal of foodstuffs from the work area.
- 4. Non-related personnel in the work area shall be kept to a minimum.

1.8 WARRANTY

A. Dur-A-Flex, Inc. warrants that material shipped to buyers at the time of shipment substantially free from material defects and will perform substantially to Dur-A-Flex, Inc. published literature if used in accordance with the latest prescribed procedures and prior to the expiration date. B. Dur-A-Flex, Inc. liability with respect to this warranty is strictly limited to the value of the material purchase.

PART 2 - PRODUCTS

2.1 FLOORING

- A. Dur-A-Flex, Inc, Dur-A-Quartz, Epoxy-Based seamless flooring system. Contact: Robert Jongema 615-585-2004 robertj@dur-a-flex.com.
 - 1. System Materials:
 - a. Primer: Dur-A-Flex. Inc. Dur-A-Glaze #4 resin and WB hardener.
 - b. Broadcast Coats: Dur-A-Flex, Inc, Dur-A-Glaze #4 resin and hardener.
 - c. The quartz aggregate shall be Dur-A-Flex, Inc. Q-28 colored quartz aggregate.
 - d. Grout coat: Dur-A-Flex, Inc. Dur-A-Glaze #4 resin and Water Clear hardener.
 - e. 2ND Grout coat: Dur-A-Flex, Inc. Dur-A-Glaze #4 resin and Water Clear hardener.
 - f. Topcoat: Dur-A-Flex, Inc. Armor Top resin and hardener.
 - 2. Patch Materials
 - a. Shallow Fill and Patching: Use Dur-A-Flex, Inc. Dur-A-Glaze #4 Cove Rez.
 - b. Deep Fill and Sloping Material (over ¼ inch): Use Dur-A-Flex, Inc. Dur-A-Crete.

2.2 MANUFACTURER

- A. Dur-A-Flex, Inc., 95 Goodwin Street, East Hartford, CT 06108, Phone: (860) 528-9838, Fax: (860) 528-2802
- B. Manufacturer of Approved System shall be single source and made in the USA.

2.3 PRODUCT REQUIREMENTS

Α.	Pri	mer	Dur-A-Glaze #4 WB
	1.	Percent Solids	56 %
	2.	VOC	2 g/L
	3.	Bond Strength to Concrete ASTM D 4541	550 psi, substrates fails
	4.	Hardness, ASTM D 3363	3H
	5.	Elongation, ASTM D 2370	9 %
	6.	Flexibility (1/4: Cylindrical mandrel), ASTM D 1737	Pass
	7.	Impact Resistance, MIL D-2794	>160
	6.	Abrasion Resistance ASTM D 4060,	
		CS 17 wheel, 1,000 g Load	30 mg loss

B. Broadcast Coat and Grout Coat

1.	Percent Solids	100 %
2.	VOC	0 g/L
3.	Compressive Strength, ASTM D 695	11,200 psi
4.	Tensile Strength, ASTM D 638	2,100 psi
5.	Flexural Strength, ASTM D 790	5,100 psi
6.	Abrasion Resistance, ASTM D 4060	
	C-10 Wheel, 1,000 gm load, 1,000 cycles	29 mg loss

C-10 Wheel, 1,000 gm load, 1,000 cycles 29 mg lo 7. Flame Spread/NFPA-101, ASTM E 84 Class A

8. Impact Resistance MIL D-24613 0.0007 inches, no cracking or delamination

DDG Project No.: 19.002 2018 Bond Project: Jim Hill High School Jackson Public School District Dur-A-Glaze #4

9. Water Absorption, MIL D-24613

10. Potlife @ 70 F 20 minutes

C. Topcoat

Percent Solids 1.

2. VOC

3. Tensile Strength, ASTM D 2370

4 Adhesion, ASTM 4541 5. Hardness, ASTM D 3363

60^o Gloss ASTM D 523 6.

Abrasion Resistance, ASTM D4060

CS 17 wheel (1,000 g load) 1,000 cycles

8. Pot Life, 70 F, 50% RH

Full Chemical Resistance 9

Nil

Armor Top

95 % 0 g/L 7,000 psi

Substrate Failure

>4H

Gloss 70+/-10 / Satin 50+/-10

Gloss Satin

4 8 ma loss with arit 10 12 mg loss without grit

45 mins

7 days

PART 3 - EXECUTION

EXAMINATION 3.1

A. Examine substrates, areas and conditions, with Applicator present, for compliance with requirements for maximum moisture content, installation tolerances and other conditions affecting flooring performance.

Verify that substrates and conditions are satisfactory for flooring installation and comply with requirements specified.

3.2 **PREPARATION**

Α. General

- The substrate is existing floor tile, the floor must be shallow patched with Dura-Flex Cove Rez product to fill in tile grout lines. New and existing surfaces shall be free of oil, grease, curing compounds, loose particles, moss, algae growth, laitance, friable matter, dirt, and bituminous products.
- Moisture Testing: Perform tests recommended by manufacturer and as follows.
 - a. Perform relative humidity test using is situ probes, ASTM F 2170. Proceed with installation only after substrates have a maximum 75% relative humidity level measurement.
 - b. If the vapor emission exceeds 75 % relative humidity or 3 lbs/1,000 sf/24 hrs then Dur-A-Flex, Inc Dur-A-Glaze MVP Primer moisture mitigation system must be installed prior to resinous flooring installation. Slab-on grade substrates without a vapor barrier may also require the moisture mitigation system.
- There shall be no visible moisture present on the surface at the time of application of the system. Compressed oil-free air and/or a light passing of a propane torch may be used to dry the substrate.
- Mechanical surface preparation
 - a. Shot blast all surfaces to receive flooring system with a mobile steel shot, dust recycling machine (Blastrac or equal). All surface and embedded accumulations of paint, toppings hardened concrete layers, laitance, power trowel finishes and other similar surface characteristics shall be completely removed leaving a bare concrete surface having a minimum profile of CSP 4-5 as described by the International Concrete Repair Institute.

DDG Project No.: 19.002 2018 Bond Project: Jim Hill High School Jackson Public School District

- b. Floor areas inaccessible to the mobile blast machines shall be mechanically abraded to the same degree of cleanliness, soundness and profile using diamond grinders, needle guns, bush hammers, or other suitable equipment.
- c. Where the perimeter of the substrate to be coated is not adjacent to a wall or curb, a minimum 1/4 inch key cut shall be made to properly seat the system, providing a smooth transition between areas. The detail cut shall also apply to drain perimeters and expansion joint edges.
- d. Cracks and joints (non-moving) greater than 1/8 inch wide are to be chiseled or chipped-out and repaired per manufacturer's recommendations.
- 5. At spalled or worn areas, mechanically remove loose or delaminated concrete to a sound concrete and patch per manufactures recommendations.

3.3 APPLICATION

A. General

- 1. The system shall be applied in six distinct steps as listed below:
 - a. Substrate preparation
 - b. Priming
 - c. First broadcast coat application with first aggregate broadcast
 - d. Second broadcast coat with second aggregate broadcast
 - e. Grout coat application, sand floor (if required)
 - f. Topcoat application
- 2. Immediately prior to the application of any component of the system, the surface shall be dry and any remaining dust or loose particles shall be removed using a vacuum or clean, dry, oil-free compressed air.
- 3. The handling, mixing and addition of components shall be performed in a safe manner to achieve the desired results in accordance with the Manufacturer's recommendations.
- 4. The system shall follow the contour of the substrate unless pitching or other leveling work has been specified by the Architect.
- 5. A neat finish with well-defined boundaries and straight edges shall be provided by the Applicator.

B. Primer

- 1. The primer shall consist of a liquid resin and hardener that is mixed at the ratio of 1 part resin to 4 parts hardener per the manufacturer's instructions.
- 2. The primer shall be applied by 1/8 inch notched squeegee and back rolled at the rate of 200 sf/gal to yield a dry film thickness of 4 mils.

C. Broadcast Coat

- The broadcast coat shall be applied as a double broadcast system as specified by the Architect.
- 2. The broadcast coat shall be comprised of two components, a resin, and hardener as supplied by the Manufacturer and mixed in the ratio of 2 parts resin to 1 part hardener.
- 3. The resin shall be added to the hardener and thoroughly mixed by suitably approved mechanical means.
- 4. The broadcast coat shall be applied over horizontal surfaces using a 3/16 inch "v" notched squeegee and back rolled at the rate of 90-100 sf/gal for first broadcast.
- 5. Colored quartz aggregate shall be broadcast to excess into the wet material at the rate of 0.5 lbs/sf.
- 6. Allow material to fully cure. Vacuum, sweep and/or blow to remove all loose aggregate.
- 7. Apply a second coat of resin with a coverage rate of 90-100 sf/gal and broadcast aggregate to excess at the rate of 0.5 lbs/sf using a flat squeegee

8. Allow material to fully cure. Vacuum, sweep and/or blow to remove all loose aggregate.

D. Grout Coat

- 1. The grout coat shall be comprised of a liquid resin and a liquid hardener that is mixed in the ratio of 1 part hardener to 2 parts resin and installed per the manufacturer's recommendations.
- 2. The grout coat shall be flat squeegee applied and back rolled with a coverage rate of 90-100 sf/gal.

E. Topcoat

- 1. The topcoat of Armor Top shall be roller applied at the rate of 500 sf/gal to yield a dry film thickness of 3 mils.
- 2. The topcoat shall be comprised of a liquid resin, hardener and grit that is mixed per the manufacturer's instructions.
- 3. The finish floor will have a nominal thickness of 1/8 inch.

3.4 FIELD QUALITY CONTROL


- A. Tests, Inspection
 - The following tests shall be conducted by the Applicator:
 - a. Temperature
 - 1. Air, substrate temperatures and, if applicable, dew point.
 - b. Coverage Rates
 - 1. Rates for all layers shall be monitored by checking quantity of material used against the area covered.

3.5 CLEANING AND PROTECTION

- A. Cure flooring material in compliance with manufacturer's directions, taking care to prevent their contamination during stages of application and prior to completion of the curing process.
- B. Remove masking. Perform detail cleaning at floor termination, to leave cleanable surface for subsequent work of other sections.

END OF SECTION

DDG Project No.: 19.002 2018 Bond Project: Jim Hill High School Jackson Public School District

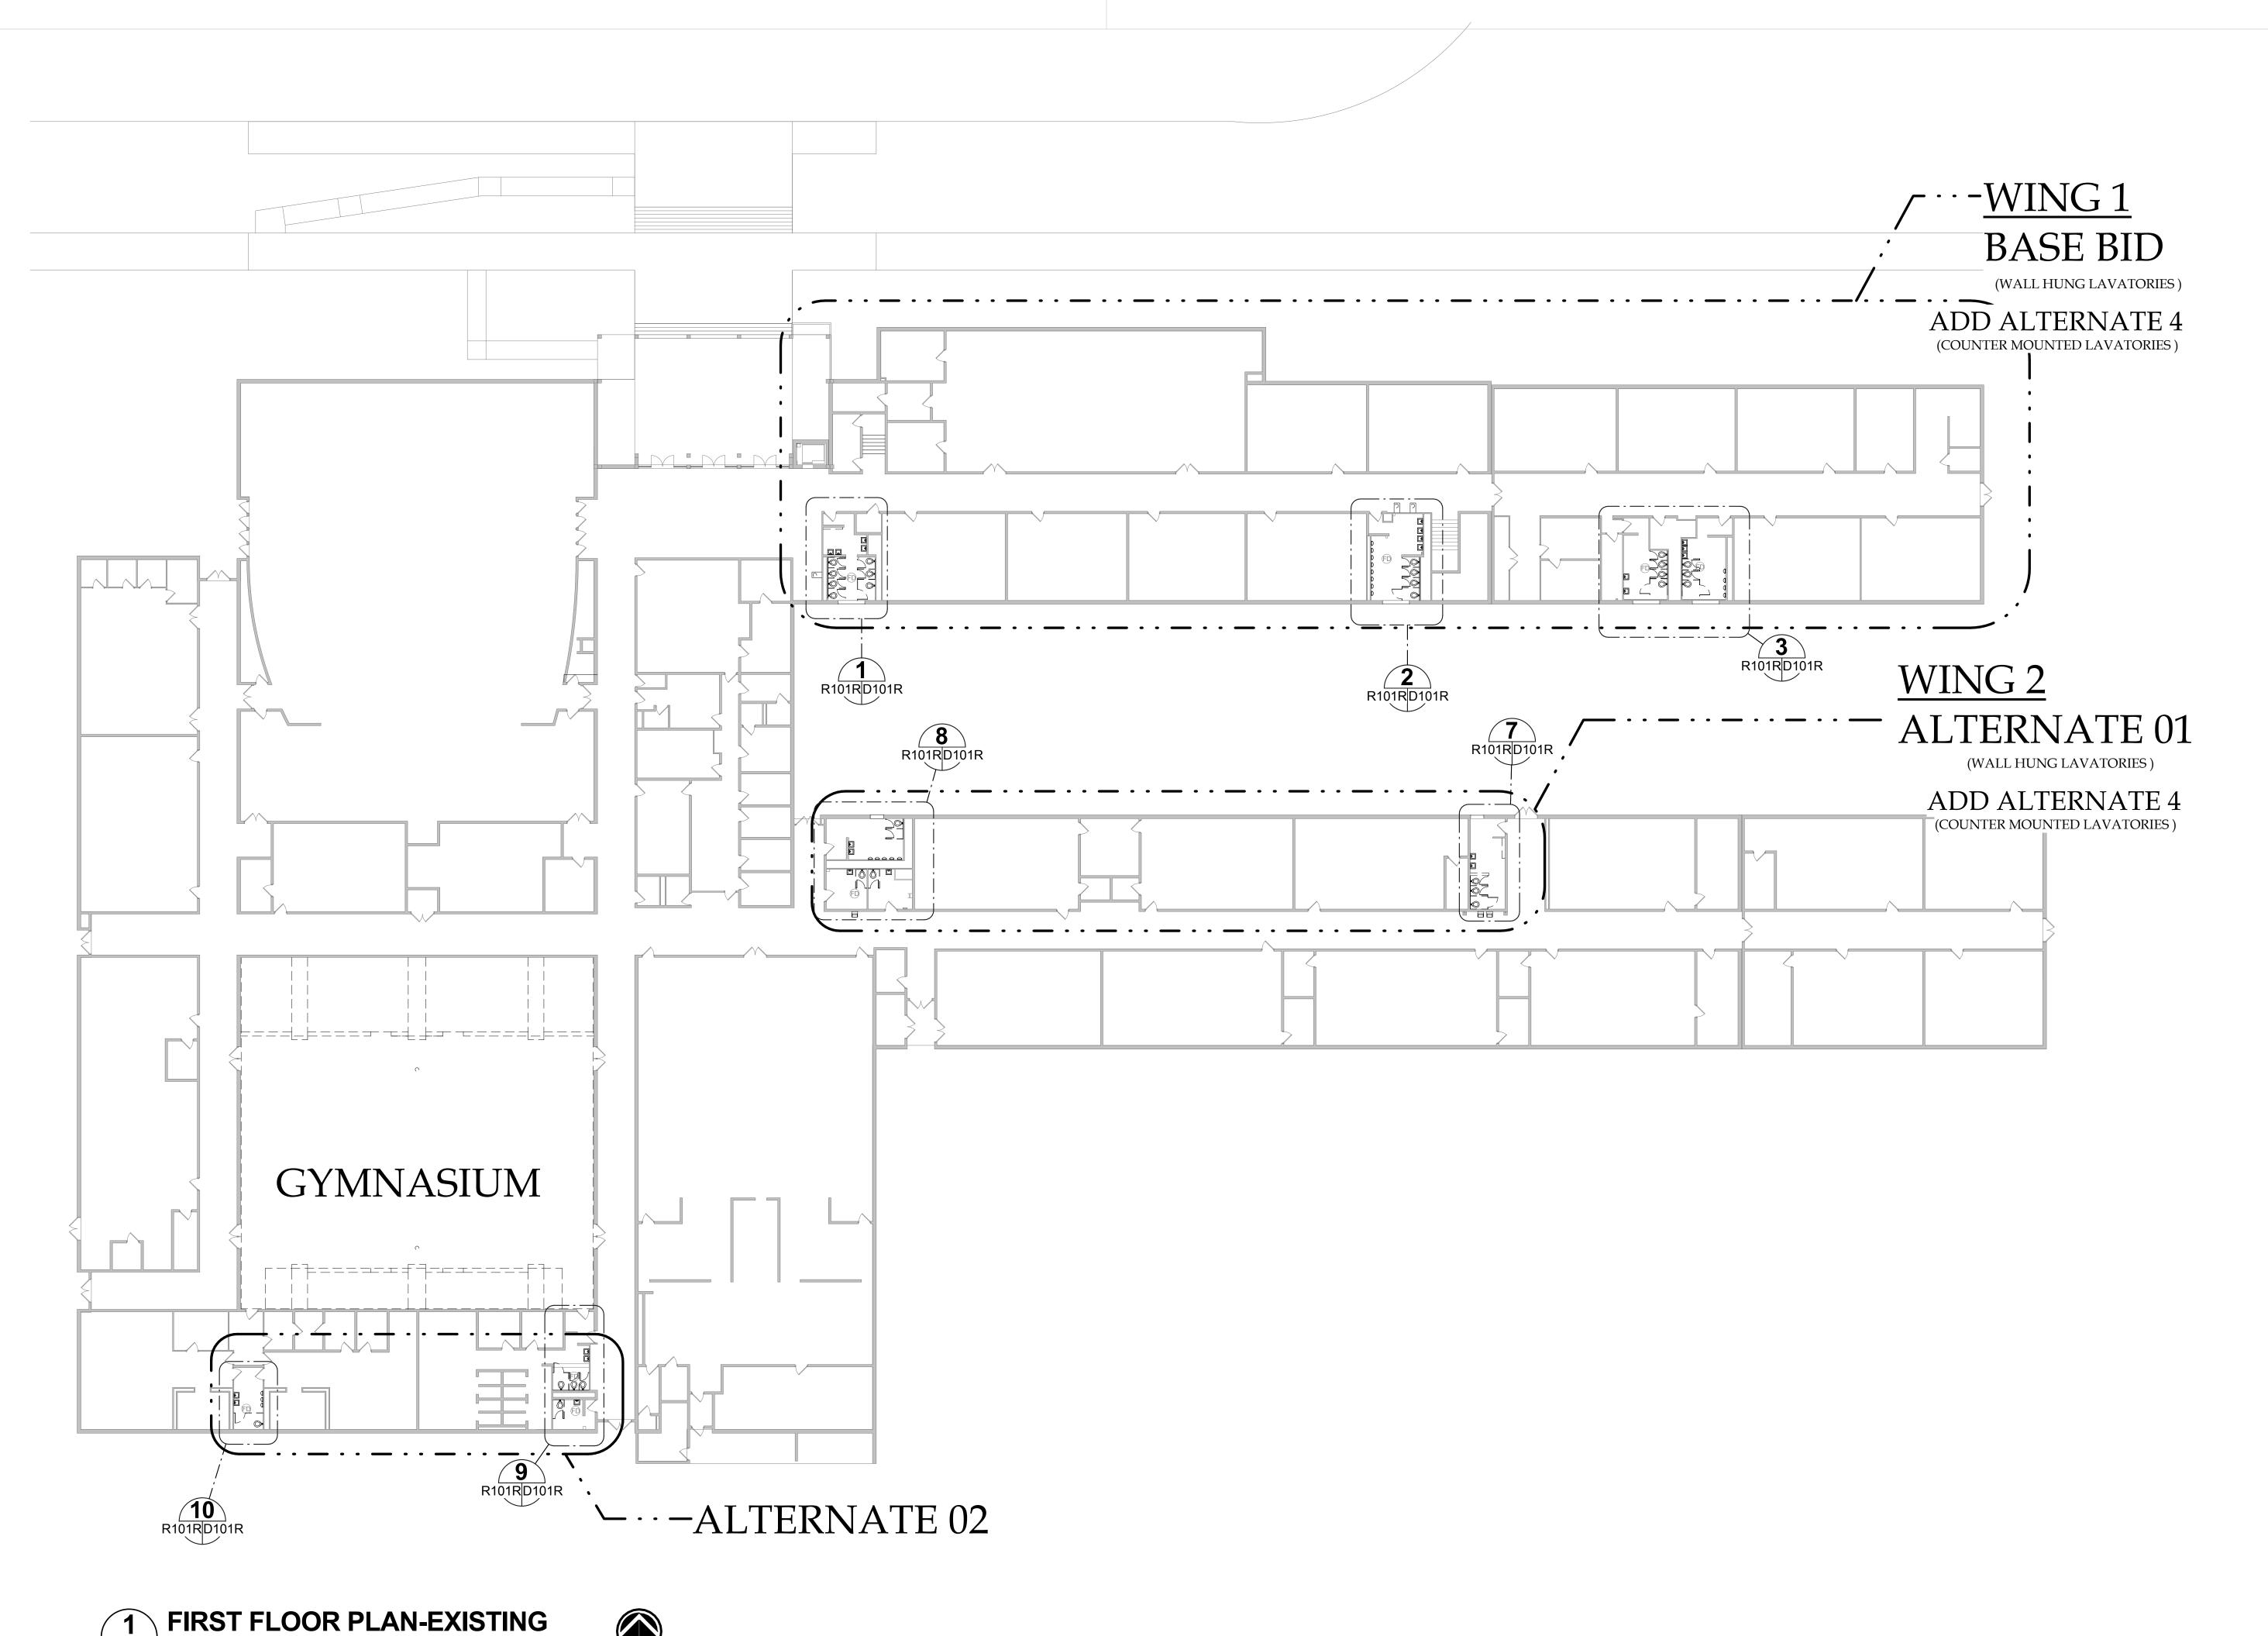

1" = 20'-0"

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Seal



BOND PROJECT: RESTROOM IMPROVEMENTS
JIM HILL HIGH SCHOOL
KSON PUBLIC SCHOOLS

Project 19.002
Number: _____02.DEC.2019
Date: _____02.DEC.2019

Drawn by: _____
Checked by: ____

Checked by: ______

Revisions


1 ____1/15/2020

3 _____

FLOOR PLAN -EXISTING

Sheet Number 2 of 20

R101R

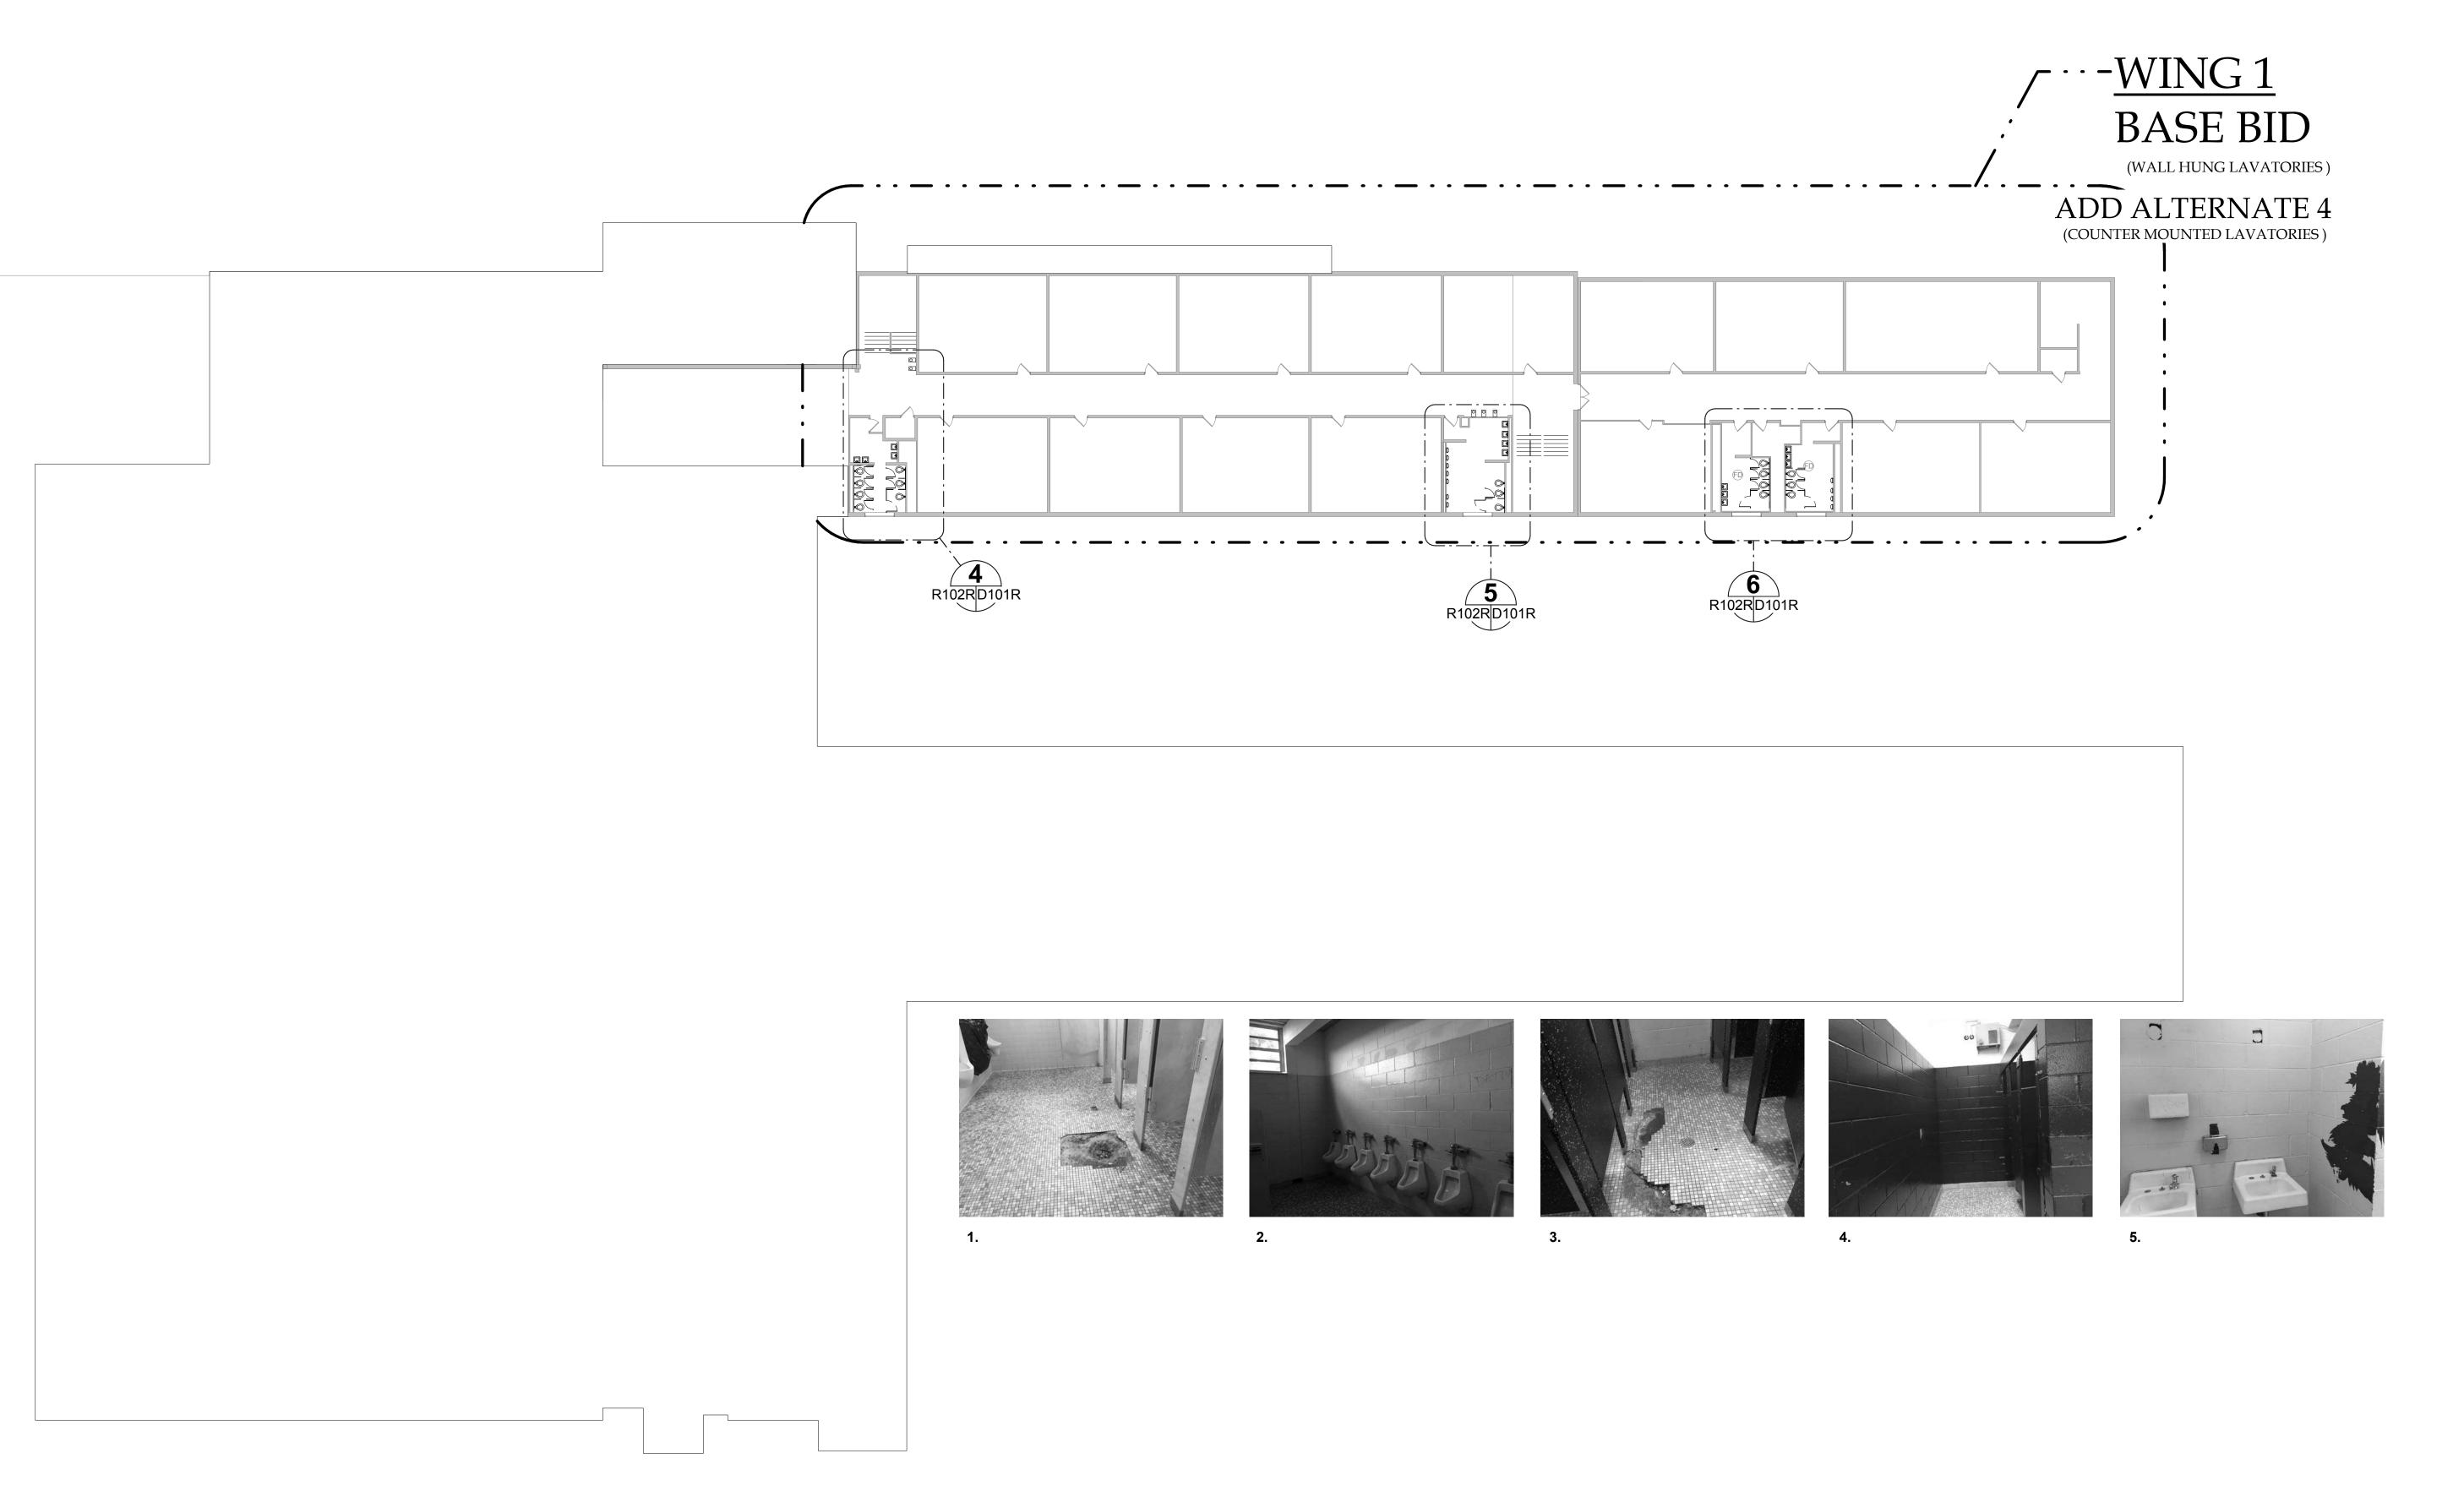

SECOND FLOOR PLAN - EXISTING 1" = 20'-0"





PHOTOS 3/4" = 1'-0"

PHOTOGRAPHS NOTE:

1. THESE EXISTING PHOTOGRAPHS ARE TO PROVIDE THE CONTRACTOR AND HIS SUBCONTRACTORS WITH VISUAL REPRESENTATION OF THE EXISTING CONDITIONS, MATERIALS AND FINISHES. THE PHOTOGRAPHS ARE NOT INTENDED TO BE A SUBSTITUTE FOR THE CONTRACTOR OR HIS SUBCONTRACTORS TO PERFORM THEIR OWN ON-SITE REVIEW OF THE EXISTING CONDITIONS PRIOR TO BIDDING THE PROJECT. T: RESTROOM IMPROVEMENTS
CHOOL
CHOOLS

Number:

Drawn by:

Revisions

Sheet Title

Checked by:

1 ____1/15/2020__

FLOOR PLAN -

EXISTING

Sheet Number 3 of 20


R102R

19.002

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ENLARGED PLAN


URINAL IS MISSING

ENLARGED PLAN

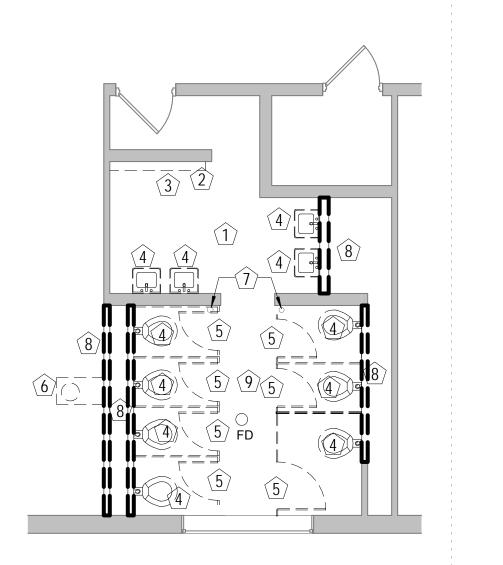BASE BID

R102R D101R 3/16" = 1'-0"

BASE BID

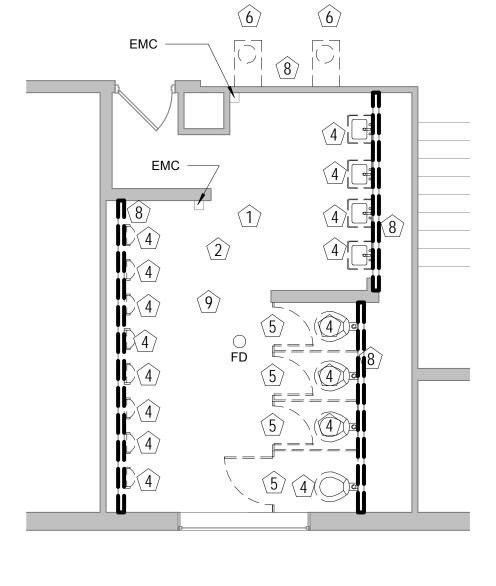

ENLARGED PLAN


BASE BID


CLOSET

MISSING


EXISTING WINDOW TO REMAIN

ENLARGED PLAN BASE BID

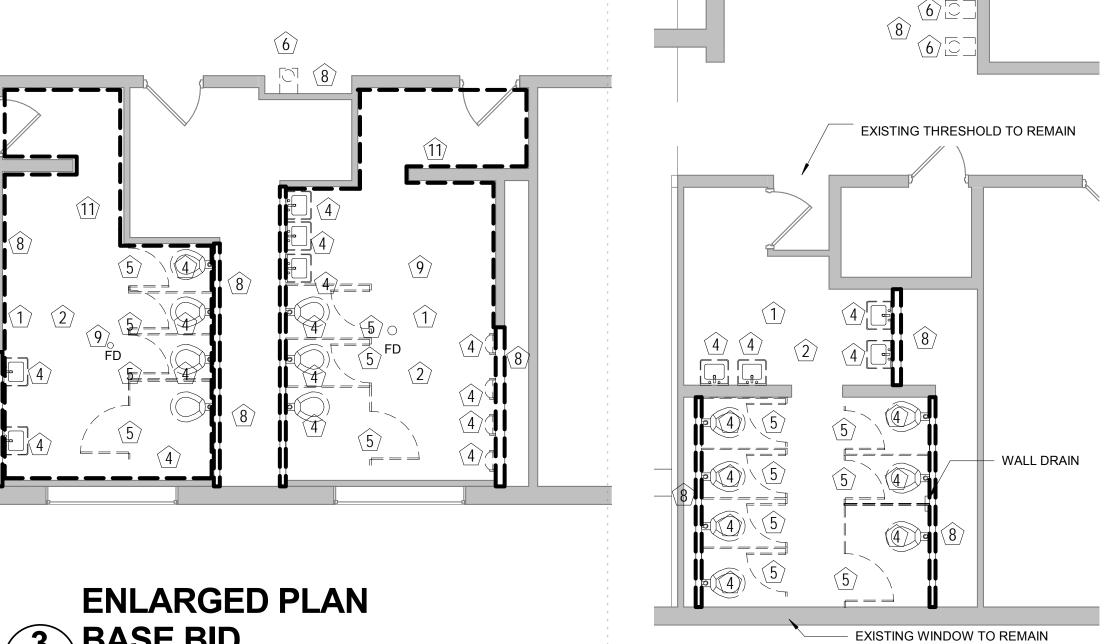

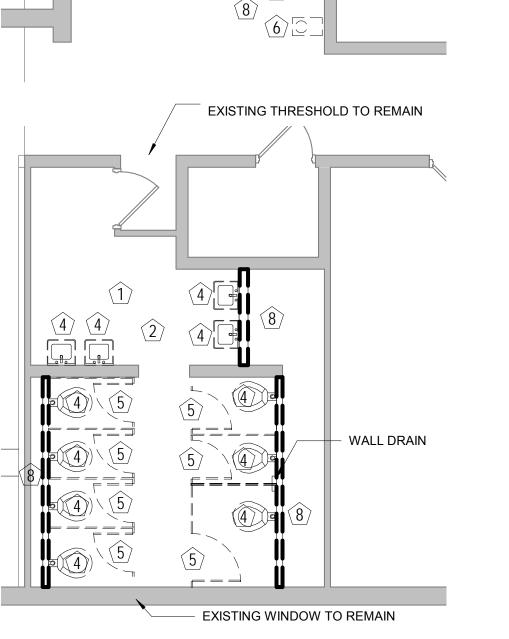


ENLARGED PLAN BASE BID

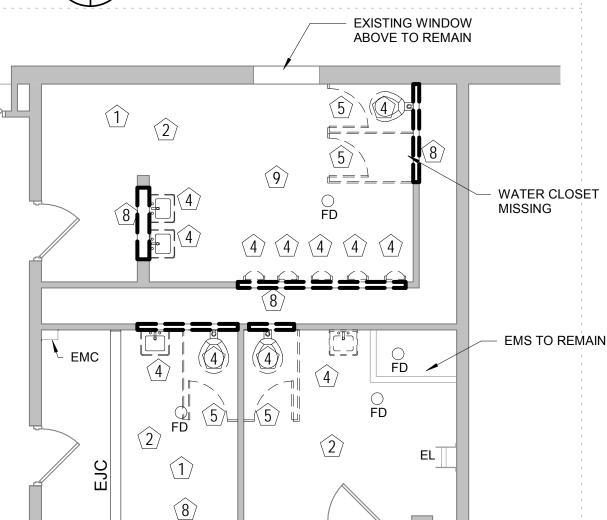

ENLARGED PLAN ALTERNATE 01 R101R D101R 3/16" = 1'-0"

R102R D101R 3/16" = 1'-0" **EXISTING WINDOW** ABOVE TO REMAIN

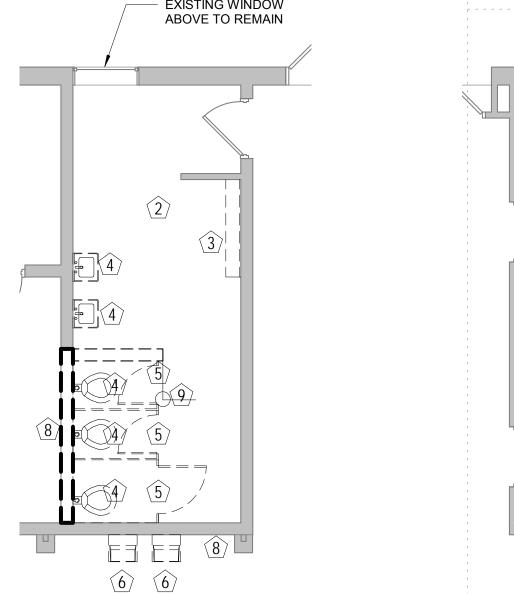

ENLARGED PLAN ALTERNATE 01 R101R D101R 3/16" = 1'-0"

5. ADD ALTERNATE 01. SCOPE OF WORK THE CONTRACTOR SHALL DEMOLISH THE EXISTING PLUMBING FIXTURE, TOILET THIS WORK WILL INCLUDE BUT NOT LIMITED TO , TOILET ACCESSORIES AND LIGHTING IN THE RESTROOM AREA FOR THE 1 STORY PORTION OF THE BUILDING DESIGNATED AS WING 2.

1. IT IS THE INTENT OF THESE DRAWINGS TO AID THE CONTRACTOR IN BIDDING THE PROJECT BY PROVIDING

HOWEVER, DEMOLITION IS EXTENSIVE AND ALL POSSIBLE

2. ALL ITEMS TO REMAIN PROPERTY OF THE OWNER WILL EITHER

OF THE CONTRACTOR AND MAY BE REMOVED FROM THE SITE

PROTECT, AND DOCUMENT LOCATIONS OF ALL UNDERGROUND

DEMOLISH THE EXISTING PLUMBING FIXTURE, TOILET PARTITION

AND ACCESORIES IN THE EXISTING TOILET AREAS. THIS WORK WILL INCLUDE BUT NOT LIMITED TO , TOILET ACCESSORIES AND LIGHTING IN THE RESTROOM AREA FOR THE 2 STORY PORTION

TURN DOCUMENTATION OF THESE OVER TO THE OWNER AT

4. BASE BID. SCOPE OF WORK THE CONTRACTOR SHALL

OF THE BUILDING DESIGNATED AS WING 1.

ITEMS/ CONDITIONS MAY NOT BE ADDRESSED. ACTUAL CONDITIONS MAY VARY FROM THOSE SHOWN IN THESE DRAWINGS. CONTRACTOR IS ADVISED TO VISIT THE SITE

BE REMOVED BY THE OWNER PRIOR TO BIDDING OR BE TAGGED BY THE OWNER PRIOR TO THE BIDDING. ALL ITEMS

3. THE CONTRACTOR IS TO LOCATE, SECURE, CAP OFF

PRIOR TO SUBMITTING HIS BID.

COMPLETION OF THE WORK.

6. ADD ALTERNATE 02. SCOPE OF WORK THE CONTRACTOR SHALL DEMOLISH THE EXISTING PLUMBING FIXTURE, TOILET ACCESSORIES AND LIGHTING IN THE RESTROOM AREA FOR THE 1 STORY PORTION OF THE BUILDING LOCATED BEHIND THE GYMNASIUM.

5. REFER TO MECHANICAL AND PLUMBING DRAWINGS FOR ADDITIONAL INFORMATION ON DEMOLITION SCOPE

6. REFER TO ELECTRICAL DRAWINGS FOR EXTENT OF ITEMS THAT WILL NEED TO BE REMOVED OR RELOCATED DURING **DEMOILTION**

LEGEND: DEMOLITION

	ITEMS TO BE DEMOLISHED
$\widehat{1}$	KEYNOTE - DEMOLITION
EMS	EXISTING MOP SINK
EDF	EXISTING DRINKING FOUNTAIN
EJC	EXISTING JOINT COVER
EL	EXISTING LADDER
EMC	EXISTING METAL COVER
EX	EXISTING
FD	FLOOR DRAIN

DEMOLITION NOTES

Keynote Number	Description
1	REMOVE EXISTING TOILET ACCESSORIES AND ALL OF ITS COMPONENTS.
2	REMOVE EXISTING LIGHT FIXURES. FIXTURES NOT SHOWN FOR CLARITY. SEE ELECTRICAL FOR ADDITIONAL INFORMATION.
3	REMOVE EXISTING MILLWORK IN ITS ENTIRETY.
4	REMOVE EXISTING PLUMBING FIXTURE AND ALL OF ITS COMPONENTS.
5	REMOVE EXISTING TOILET PARTITION AND GRAB BARS.
6	REMOVED EXISTING EDF. PREPARE WALL FOR NEW EDF. SEE PLUMBING DRAWINGS FOR ADDITIONAL INFORMATION.
7	EXISTING PIPE TO CAPPED. SEE PLUMBING FOR ADDITIONAL INFORMATION.
8	REMOVE EXISTING WALL AND WALL COMPONENTS AS REQUIRED TO EXECUTE SCOPE OF WORK. SEE PLUMBING DRAWINGS FOR ADDITIONAL INFORMATION.
9	GC TO REMOVE DAMAGE TILE AND MODIFY FLOOR AND DRAINS AS REQUIRED TO ENSURE FLOOR IS LEVELED. SEE PLUMBING FOR ADDITIONAL INFORMATION CONCERNING THE DRAINS
11	REMOVE EXISTING WALL TILE AND ALL OF ITS COMPONENTS DOWN TO THE EXISTING SUBSTRATE. GC IS TO INSPECT THE CONDITION OF SUBSTRATE AND REMOVE AS REQUIRED

GENERAL DEMOLITION NOTES

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Number:

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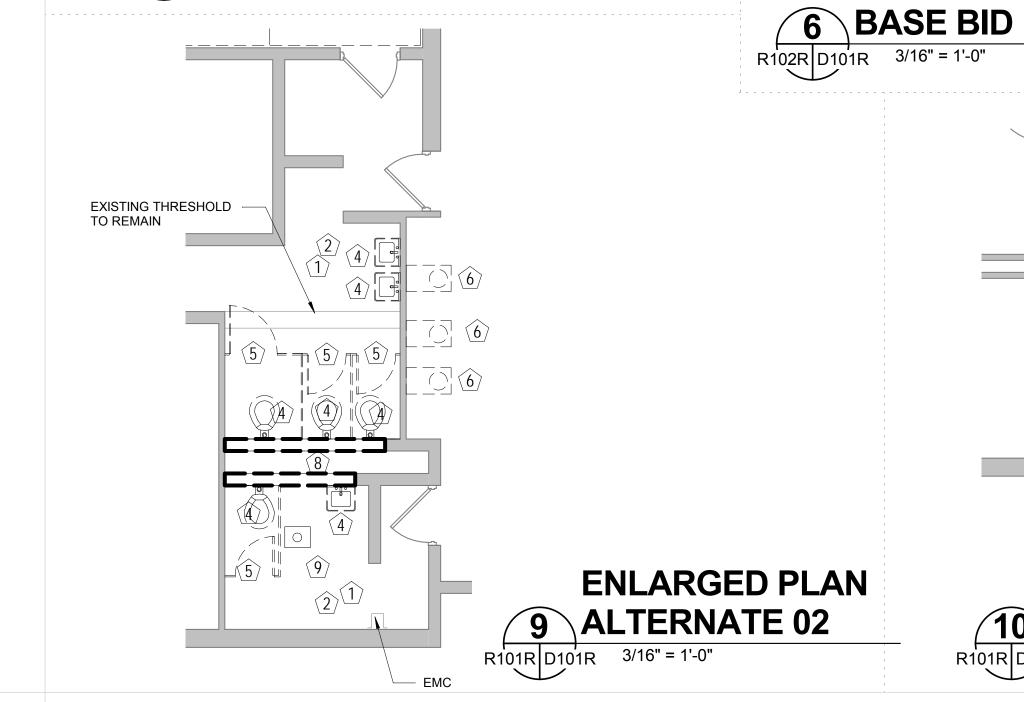
Revisions 1/15/2020


Sheet Title

DEMOLITION PLAN - TOILETS

Sheet Number 4 of 20


D101R



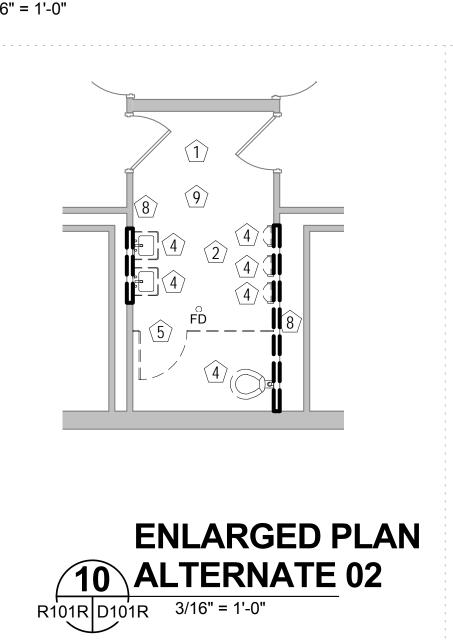


ABOVE TO REMAIN

ENLARGED PLAN

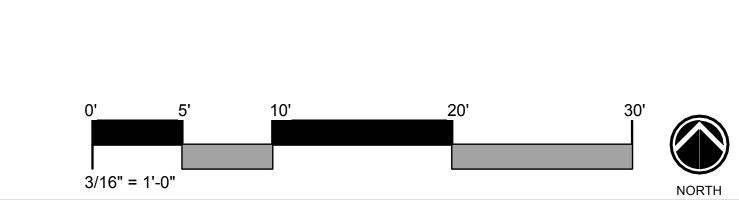


THE DEFECTIVE PORTION BEFORE INSTALLING

THE NEW SCOPE OF WORK.

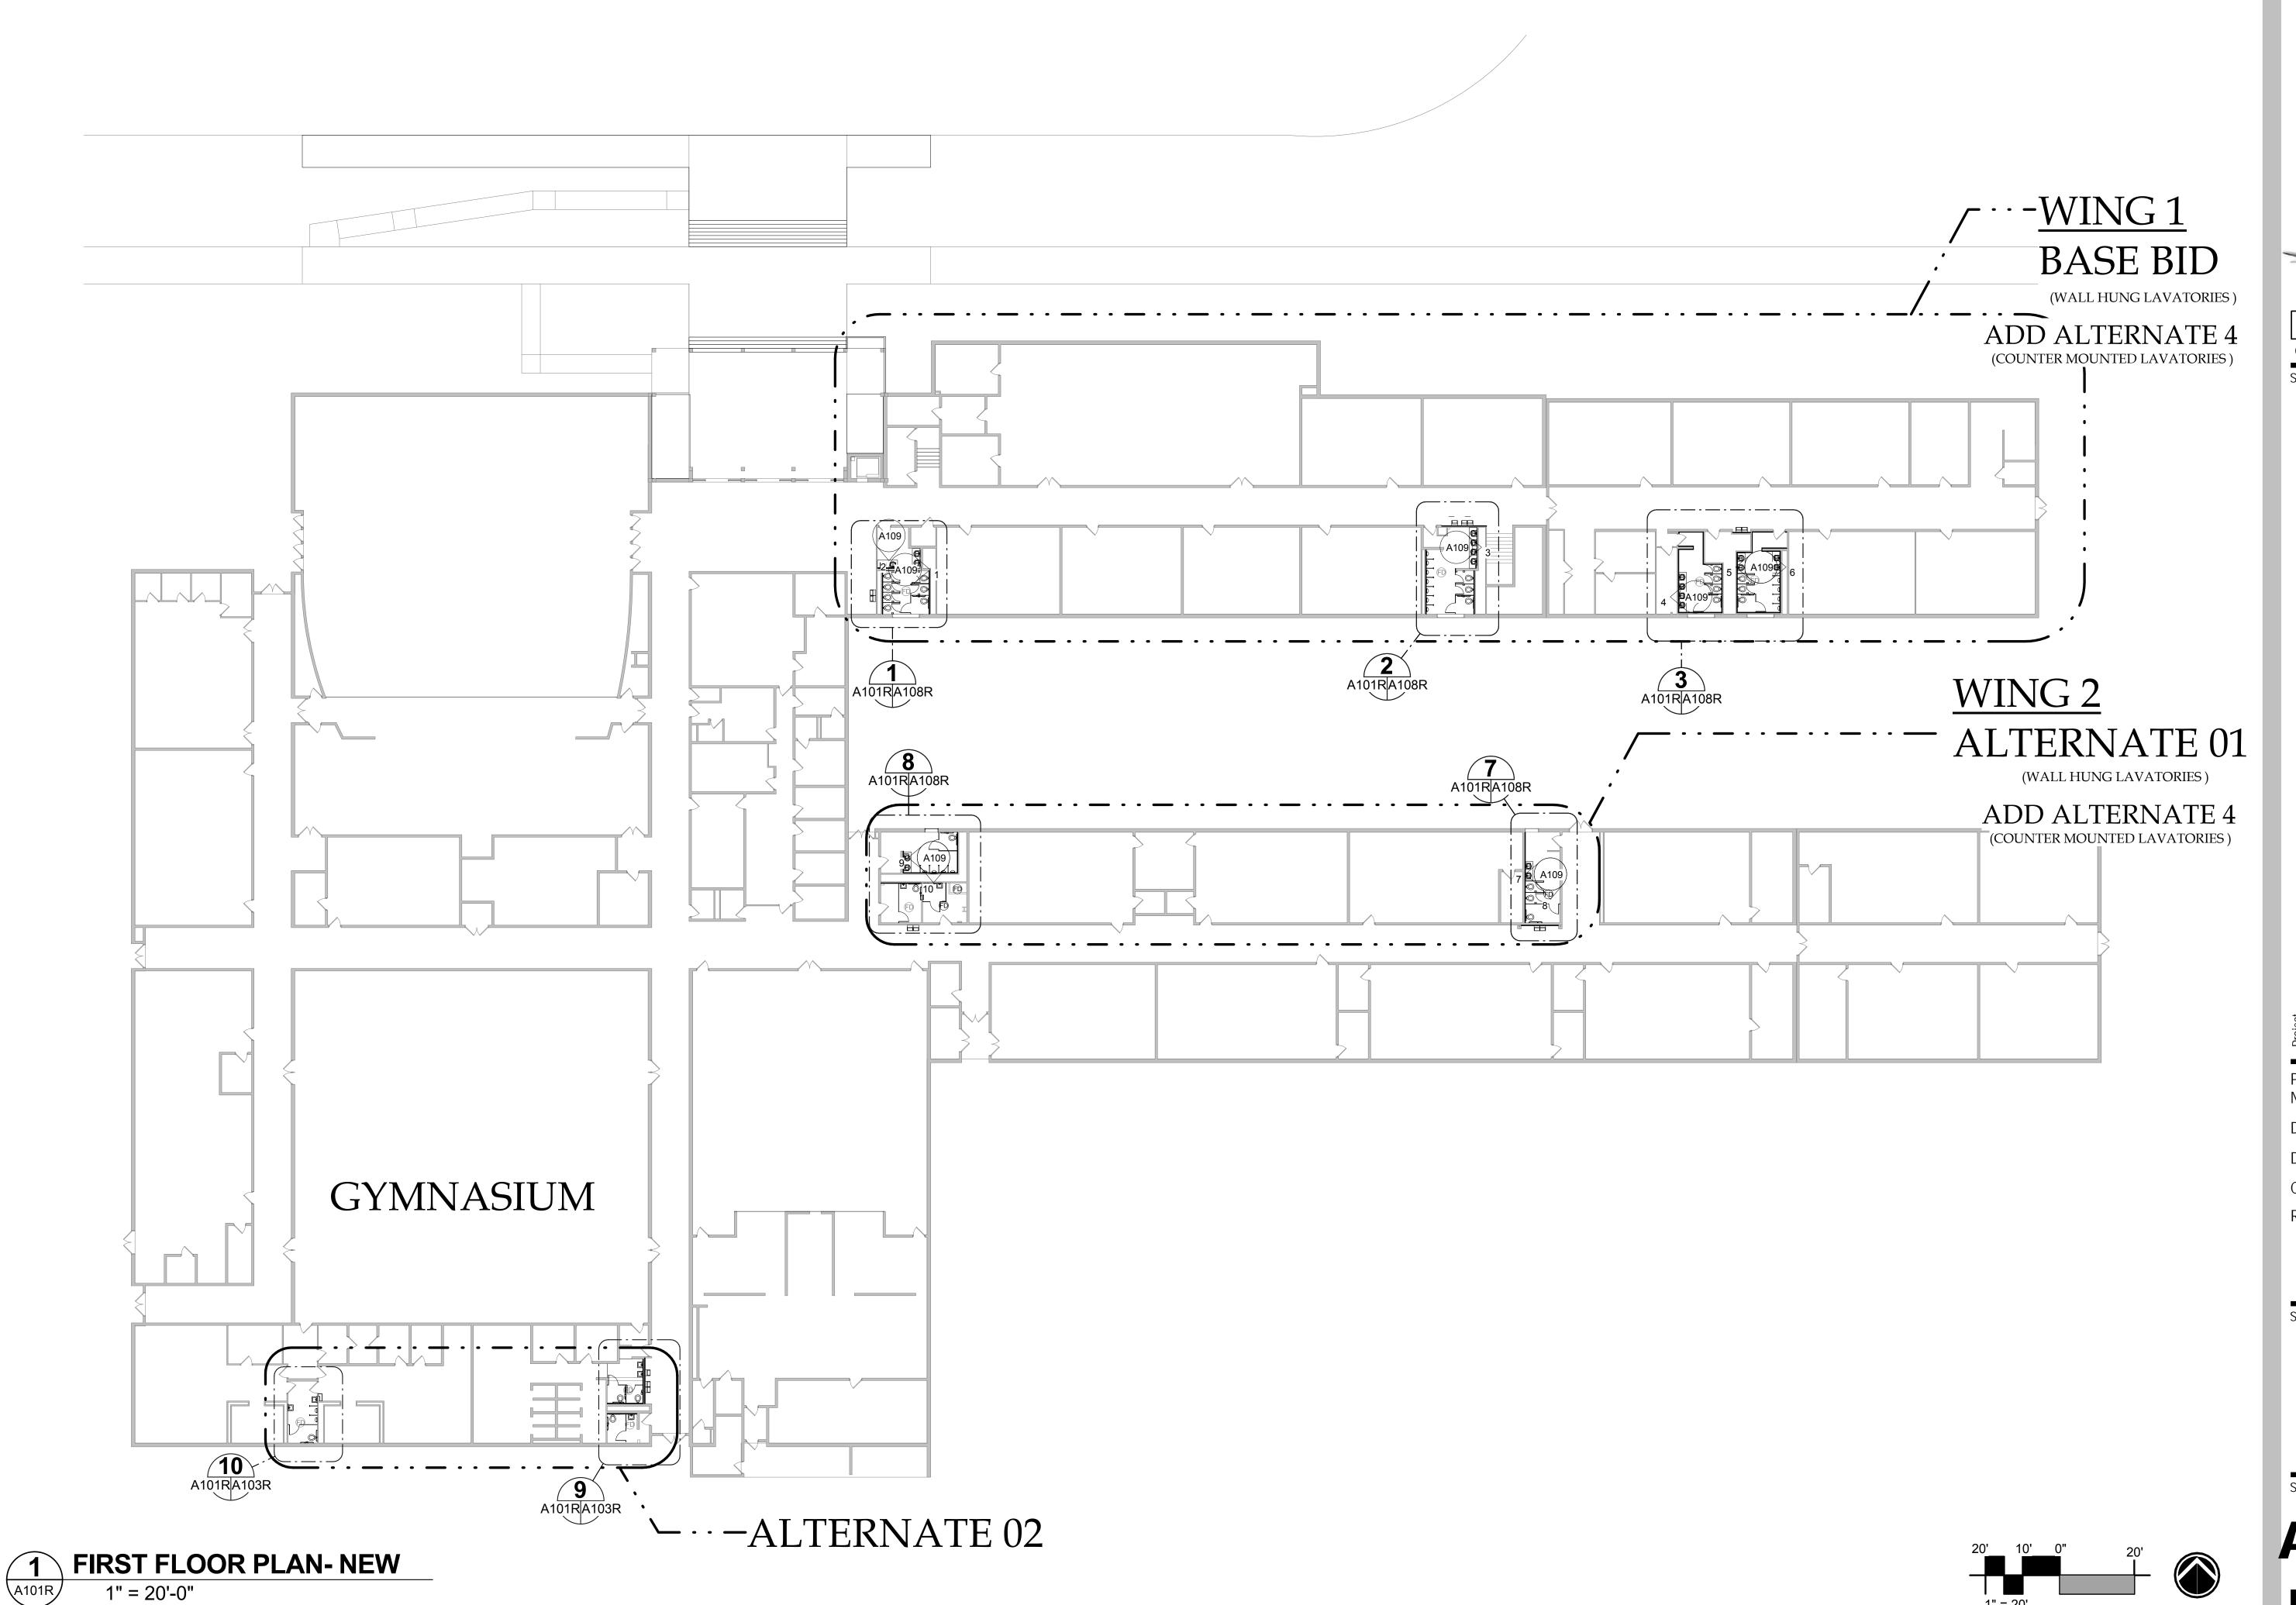

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OR JIM HILL HIGH SCHOOL

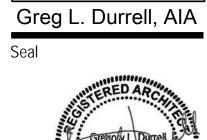ACKSON PUBLIC SCHOOLS

19.002 Number:

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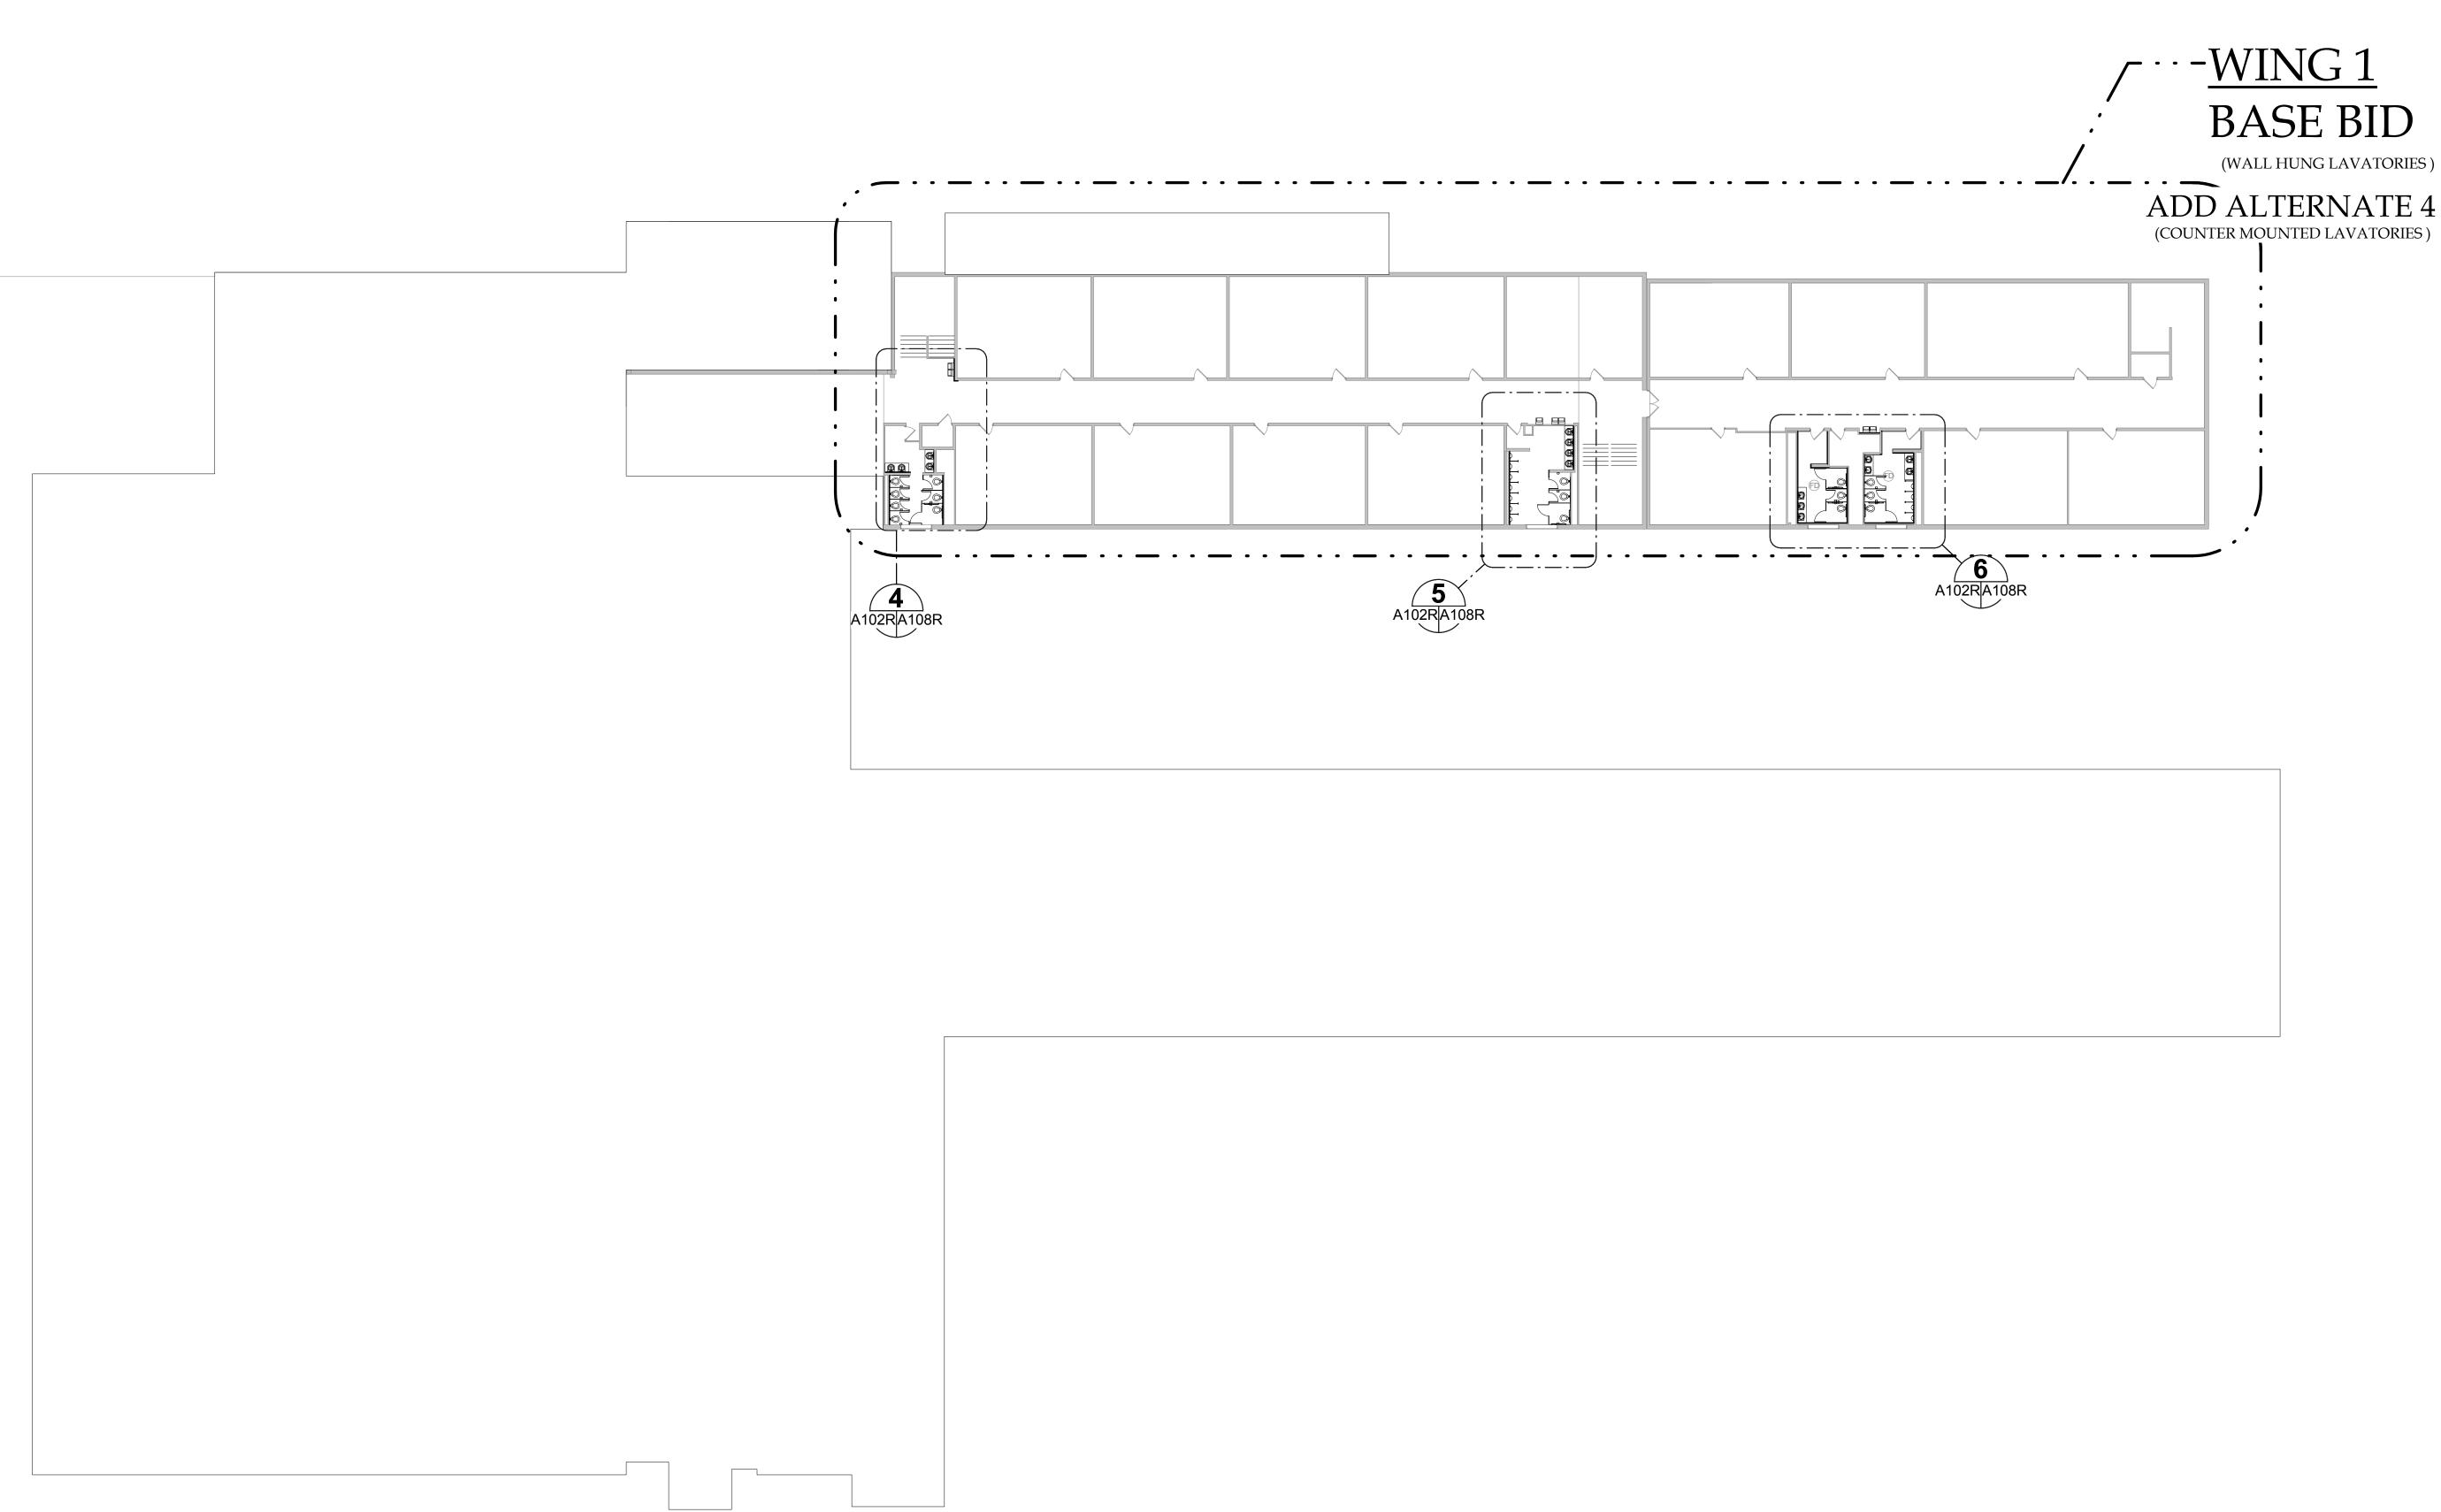
Revisions 1 ____1/15/2020_


MASTER FLOOR PLAN FIRST FLOOR - NEW WORK

Sheet Number 5 of 20

A101R

Original Plotted Sheet Size = 24"x36"



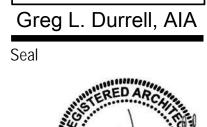

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Project Number:

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Checked by: _ Revisions 1 ____1/15/2020

MASTER FLOOR PLAN SECOND


Sheet Number 6 of 20

FLOOR - NEW

WORK

A102R

SECOND FLOOR PLAN - NEW

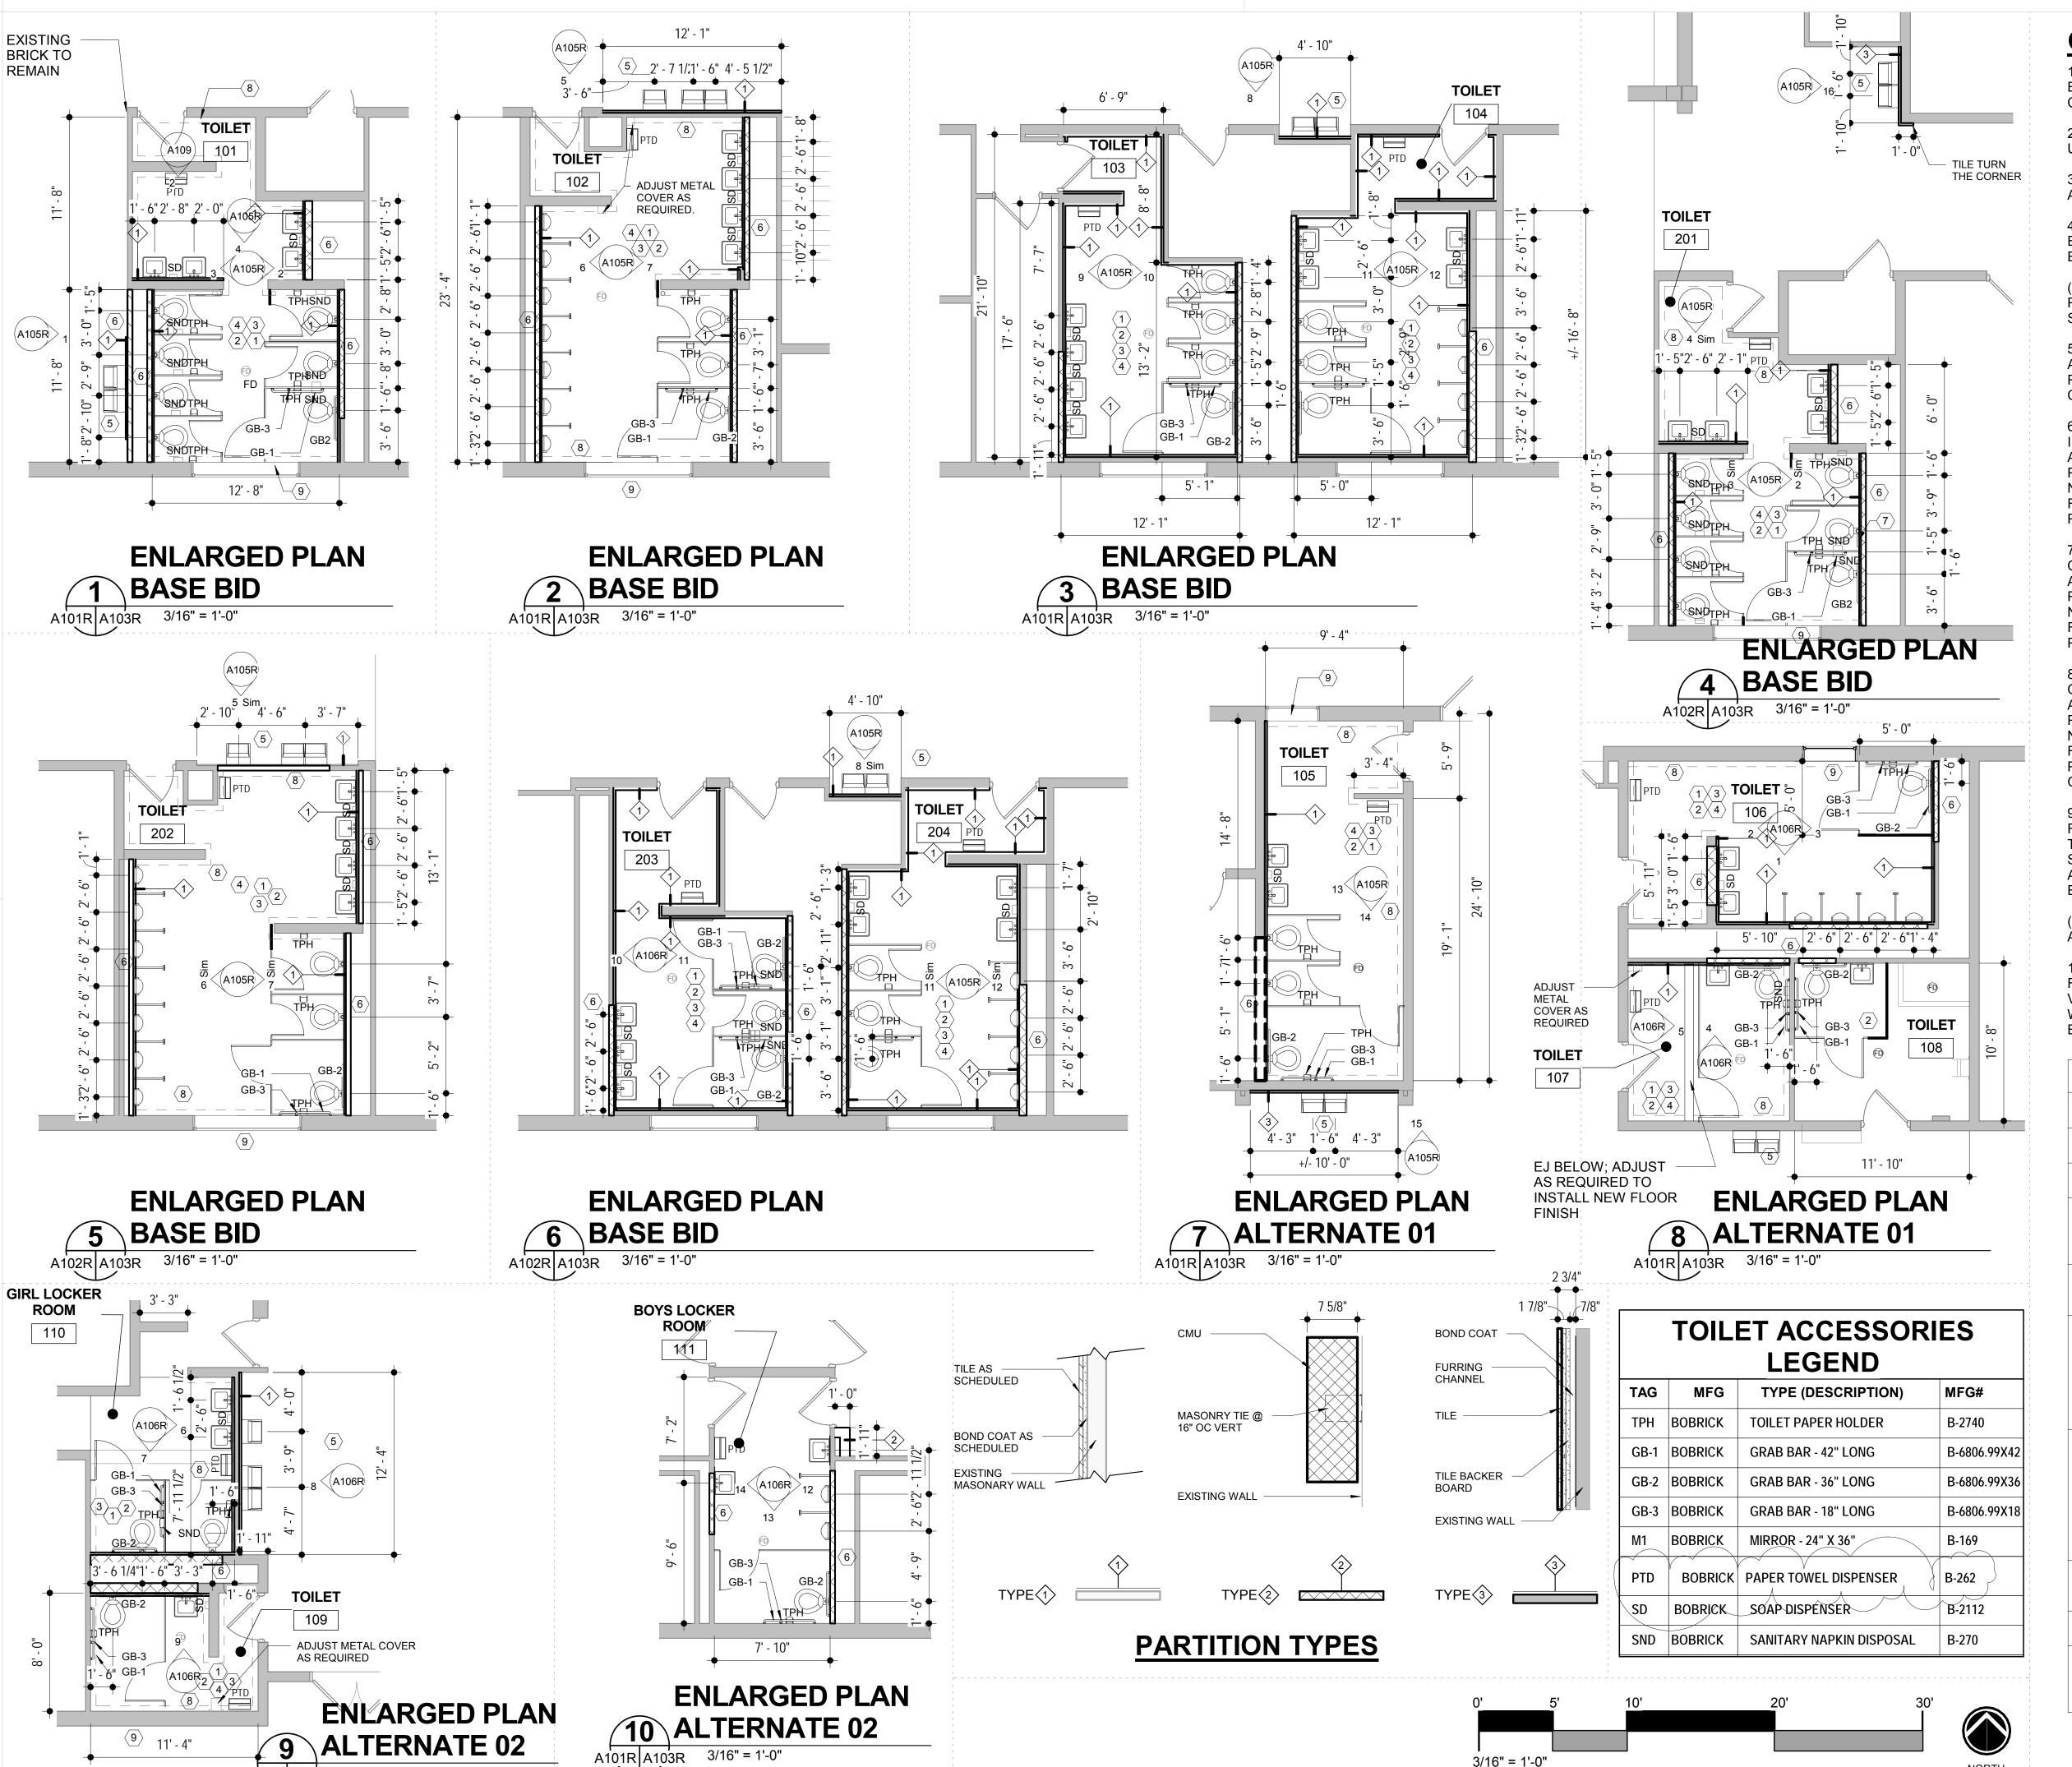

A101R A103R 3/16" = 1'-0"

3/16" = 1'-0"

GENERAL NOTES:

1. ALL DIMENSIONS ARE TO THE OUTSIDE FACE OF EXISTING WALL UNLESS NOTED OTHERWISE. CONTRACTOR IS TO FIELD VERIFY ALL DIMENSIONS.

2. ALL PARTITIONS ARE TO EXTEND TO THE DECK UNLESS NOTED OTHERWISE.

3. REFER TO PLUMBING AND ELECTRICAL SHEETS FOR ADDITIONAL REQUIREMENTS.

4. REFER TO SHEETS A105-A107 FOR INTERIOR ELEVATIONS. SEE SHEET A107 FOR TYPICAL TILE ELEVATION.

(NOTE: ALL WALLS NOT RECEIVING TILES ARE TO BE PAINTED AND NEW ELECTRICAL COVER PLATES AS SCHEDULED.)

5. THE FINISH FLOOR WILL BE REFERENCED AS 0'-0" AND ALL OTHER FLOOR ELEVATIONS, CEILINGS, ETC. WILL BE REFERENCED FROM THAT ELEVATION OR CORRESPONDING LEVEL

6. BASE BID. THE SCOPE OF WORK CONSISTS OF INSTALLING NEW PLUMBING FIXTURES, TOILET ACCESSORIES, NEW WALL TILE ON THE WET WALLS, PAINTING THE EXISTING WALL THAT DOES NOT RECEIVE NEW WALL TILE, LIGHT FIXTURES, AND NEW FLOOR FINISH IN THE RESTROOM AREA FOR THE 2 STORY PORTION OF THE BUILDING DESIGNATED AS WING 1

7. ADD ALTERNATE 01. THE SCOPE OF WORK CONSISTS OF INSTALLING NEW PLUMBING FIXTURES, TOILET ACCESSORIES, NEW WALL TILE ON THE WET WALLS. PAINTING THE EXISTING WALL THAT DOES NOT RECEIVE NEW WALL TILE, LIGHT FIXTURES, AND NEW FLOOR FINISH IN THE RESTROOM AREA FOR THE 1 STORY PORTION OF THE BUILDING DESIGNATED AS WING 2

8. ADD ALTERNATE 02. THE SCOPE OF WORK CONSISTS OF INSTALLING NEW PLUMBING FIXTURES, TOILET ACCESSORIES, NEW WALL TILE ON THE WET WALLS. PAINTING THE EXISTING WALL THAT DOES NOT RECEIVE NEW WALL TILE, LIGHT FIXTURES, AND NEW FLOOR FINISH IN THE RESTROOM AREA FOR THE 1 STORY PORTION OF THE BUILDING LOCATED BEHIND THE

9. ADD ALTERNATE 03. THE SCOPE OF WORK IS AS FOLLOWS: ALL WALLS IN THE RESTROOMS ARE TO BE TILED TO THE HEIGHT OF EXISTING DECK OR STRUCTURE. SEE ALTERNATE ELEVATION FOR ADDITIONAL INFORMATION. REFER TO TYPICAL TILE ELEVATION FOR TILE LAYOUT.

(NOTE: DOTTED LINES ON PLANS INDICATES THE ALTERNATE SCOPE OF WORK.)

10. ADD ALTERNATE 04. THE SCOPE OF WORK IS AS WALL MOUNTED VANITIES. SEE ALTERNATE PLANS AND ELEVATIONS FOR ADDITIONAL INFORMATION.

CONSTRUCTION NOTES

Keynote Number	Description
1	GC TO PREP EXISTING FLOOR FOR NEW FLOOR FINISH.
2	PROVIDE NEW URINAL AND TOILET PARTITIONS.
3	GC TO REPAIR AND PREP WALL TO RECEIVE NEW FINISH. COORDINATE WITH PLUMBING AND ELECTRICAL SHEETS FOR ADDITIONAL INFORMATION.
4	PREP AND PAINT EXISTING CEILING. COLOR AS SCHEDULED. SEE SHEET A104 FOR ADDITIONAL INFORMATION.
5	PROVIDE NEW DRINKING FOUNTION. SEE PLUMBING DRAWINGS FOR ADDITIONAL INFORMATION. GC TO PATCH AND REPAIR WALL / FLOOR AS REQUIRED. ON FLOOR REPAIR PROVIDE NEW VCT MATERIAL IS TO MATCH THE ADJACENT FLOOR FINISH IN SIZE AND COLOR.
6	GC TO MODIFY THE WALL AS REQUIRED TO INSTALL NEW FIXTURE COMPONENTS. GC SHALL INSTALL NEW MATERIAL THAT MATCHES THE ADJACENT WALL MATERIAL UNLESS OTHERWISE NOTED. GC SHALL COORDINATE THE INSTALLATION OF NEW COMPONETS WITH THE PLUMBING DRAWINGS.
7	WALL DRAIN TO REMAIN. MODIFY AS REQUIRED TO INSTALL NEW WORK. SEE PLUMBING FOR ADDITIONAL INFORMATION.
8	ADD ALTERNATE. PROVIDE NEW WALL TILE UP TOEXISTING DECK OR STRUCTURE.
9	ADD ALTERNATE. PROVIDE NEW TILE IN WINDOW JAMB AND HEAD. PROVIDE SS-1 IN THE SILL. SS-1 TO OVER HANG WALL TILE BY

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RESTROOM IMPROVEMENTS HOOL IOOLS 2018 BOND PROJECT: R FOR JIM HILL HIGH SCH JACKSON PUBLIC SCH(

19.002 Number: 02.DEC.2019 Date:


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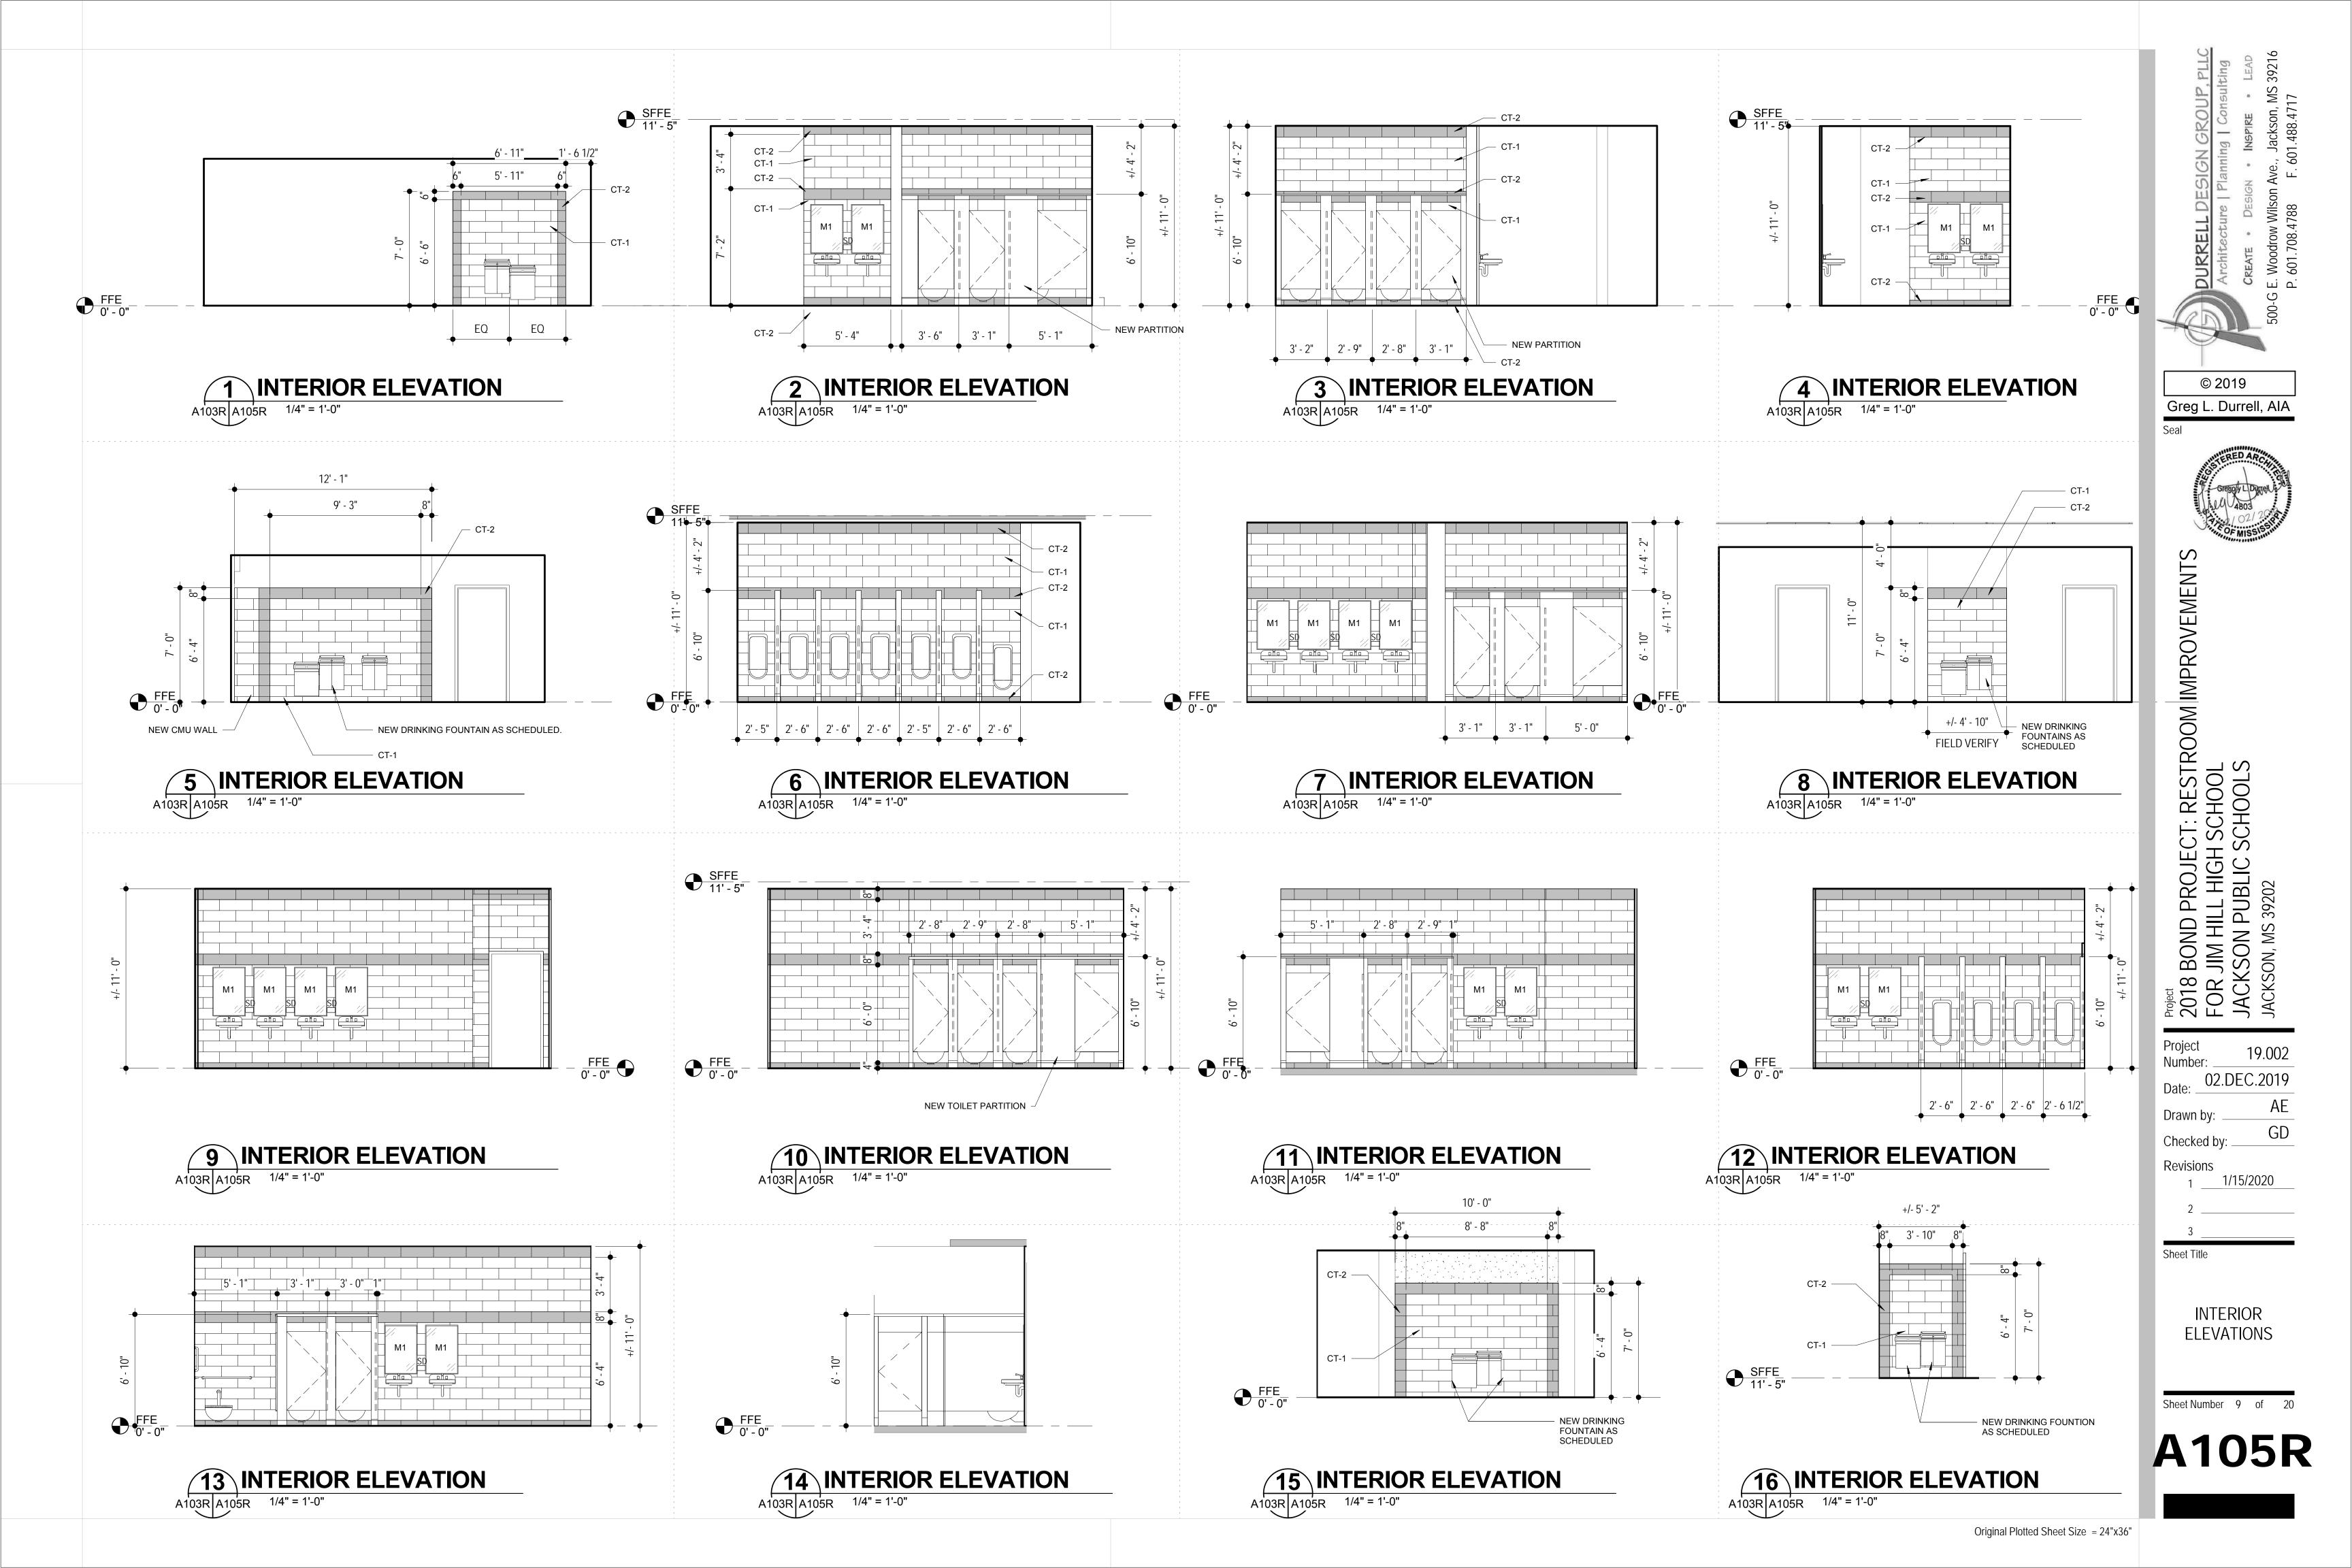
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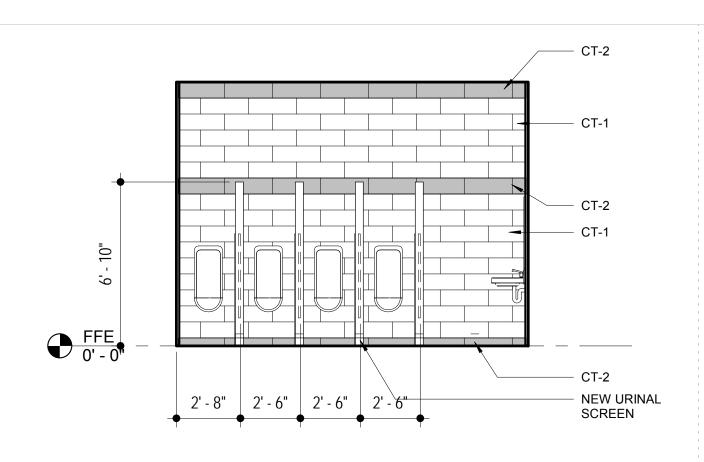
RENOVATION **ENLARGED** PLANS TOILETS

Sheet Number 7 of 20


A103R






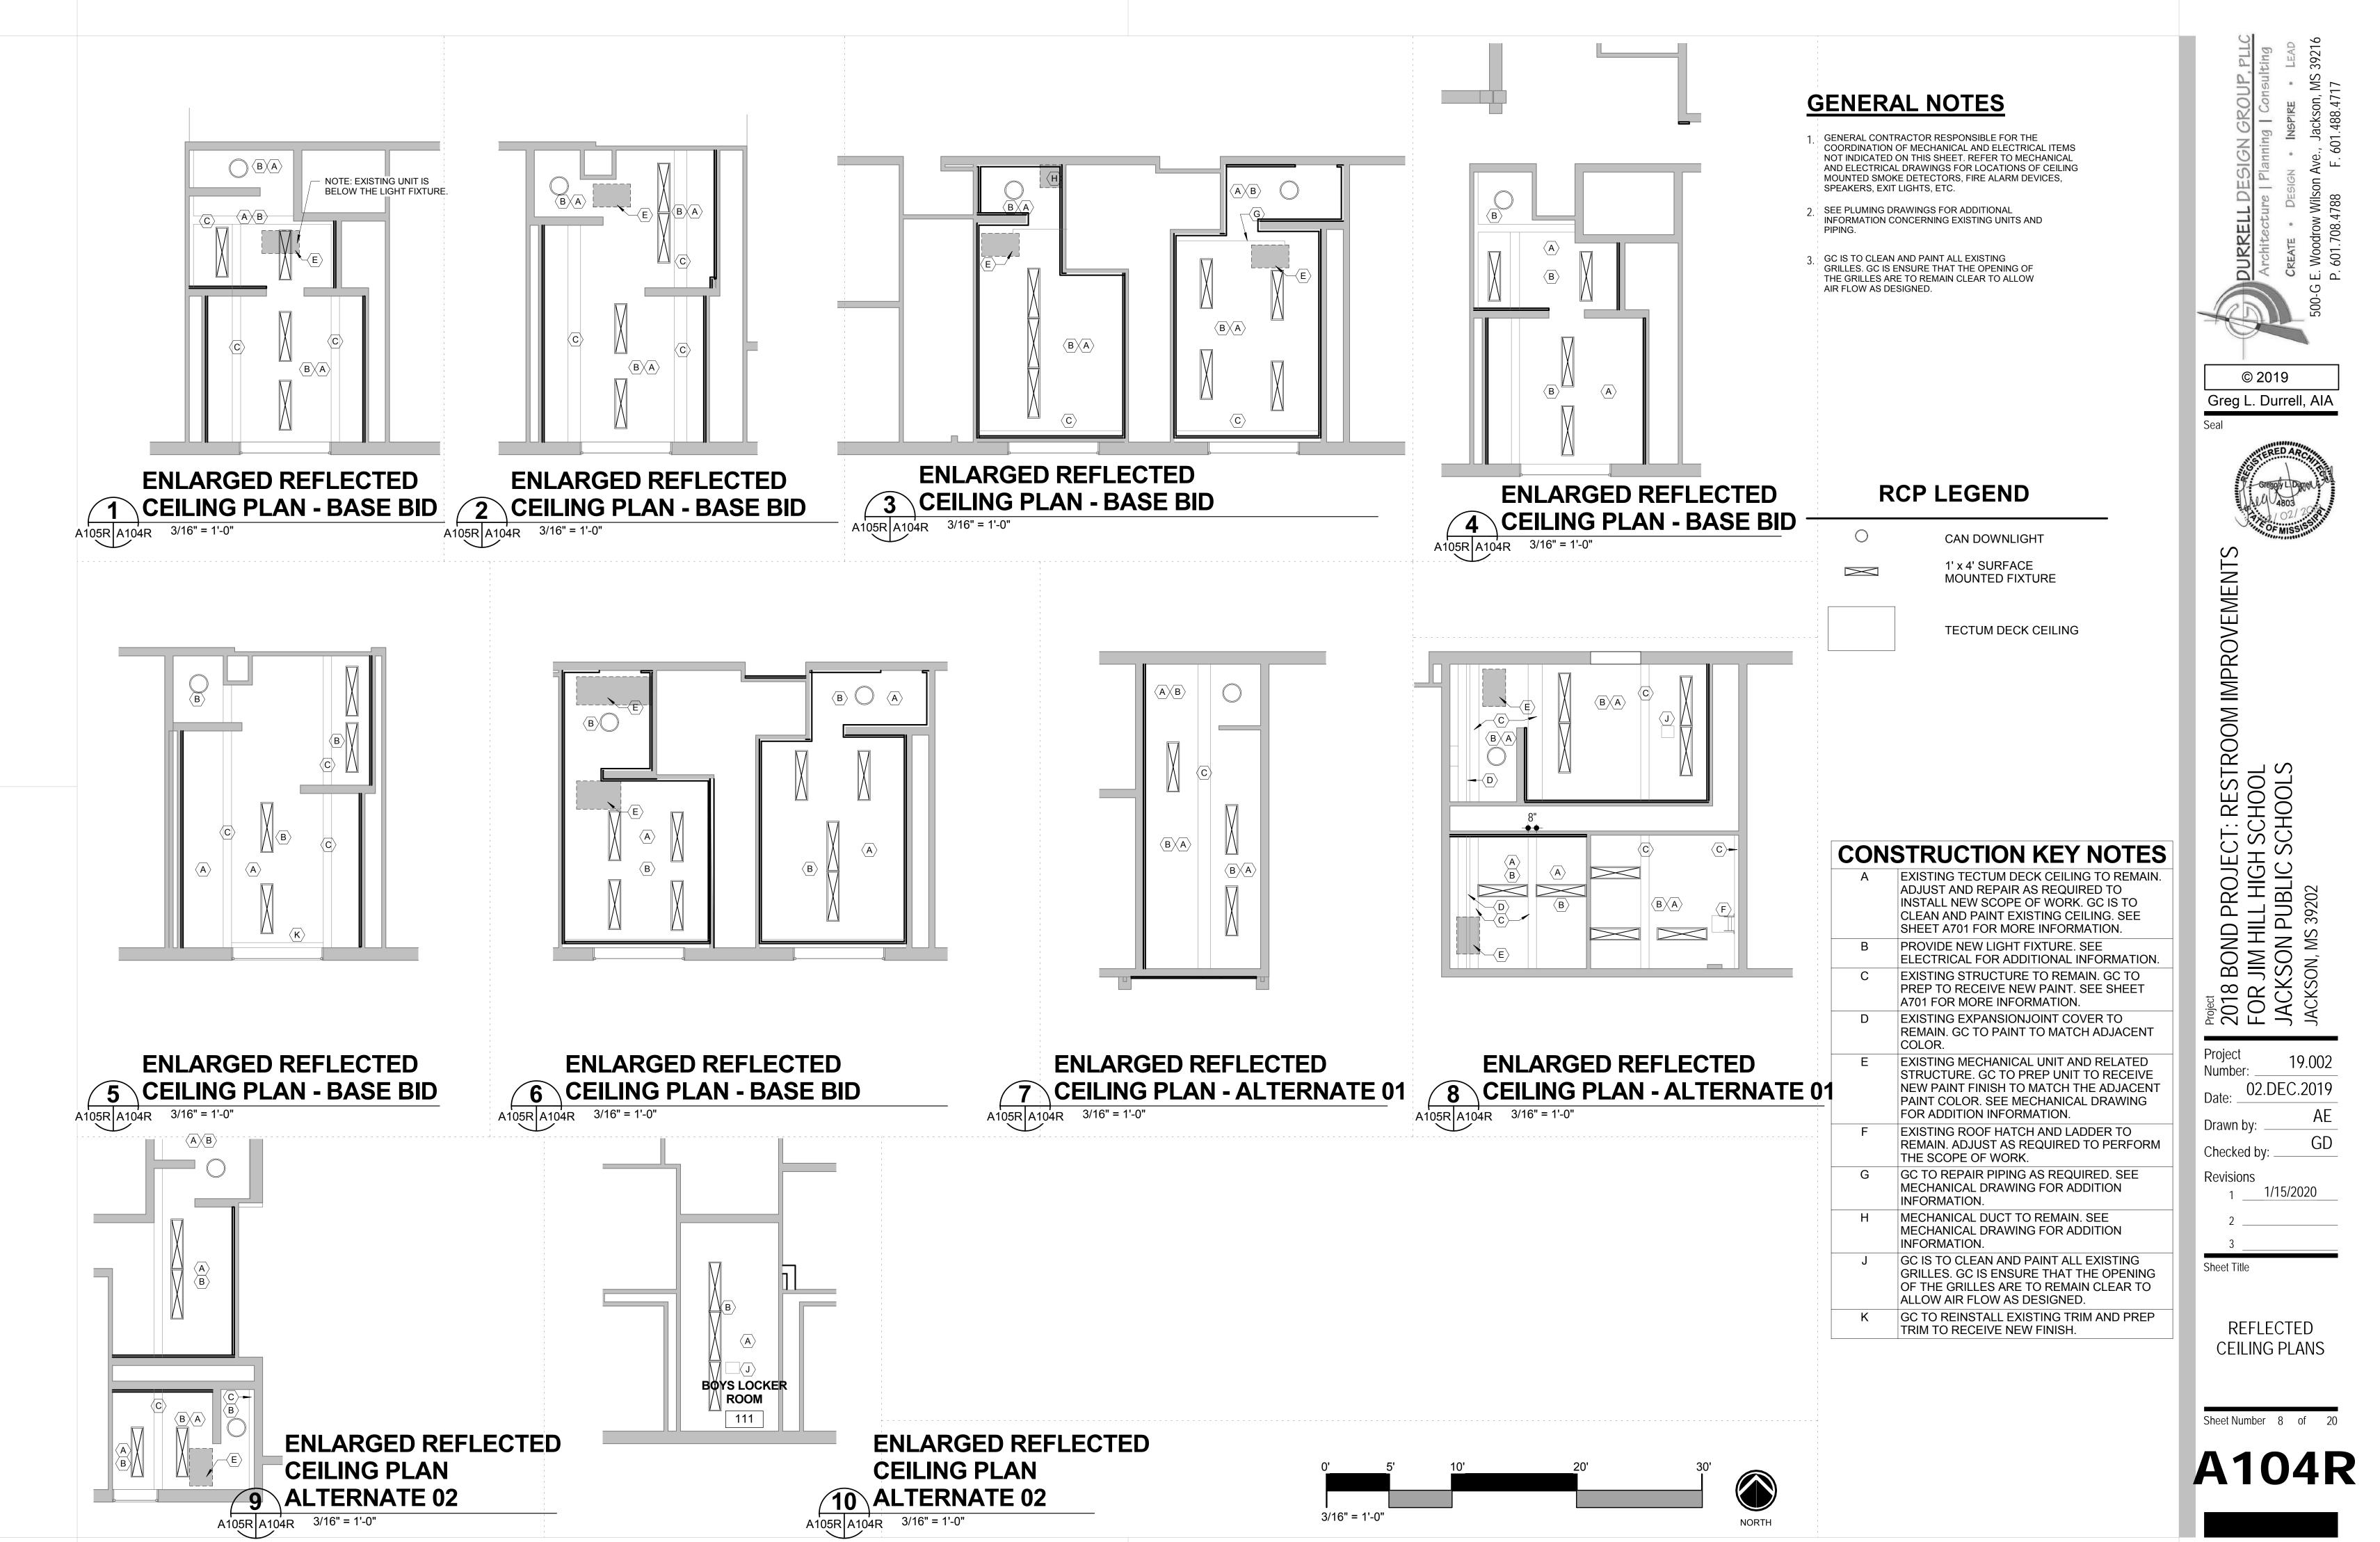




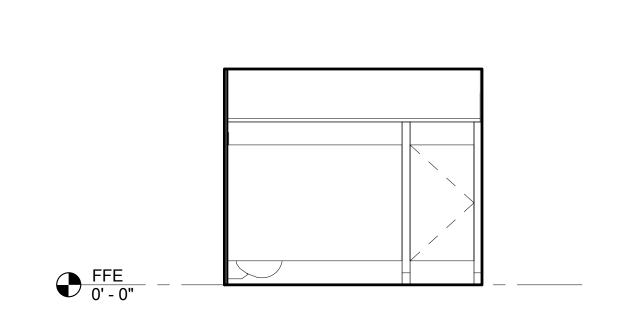


5 INTERIOR ELEVATION A103R A106R 1/4" = 1'-0"

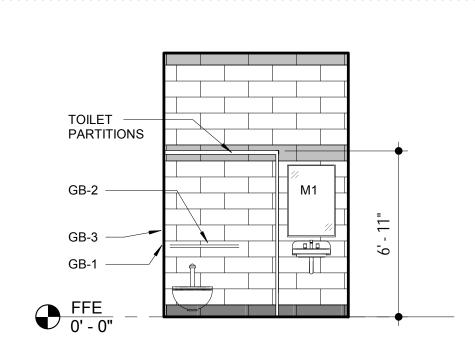


9 INTERIOR ELEVATION A103R A106R 1/4" = 1'-0"

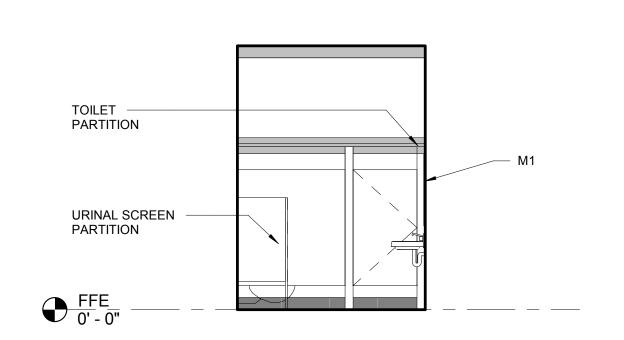


13 INTERIOR ELEVATION
A103R A106R 1/4" = 1'-0"

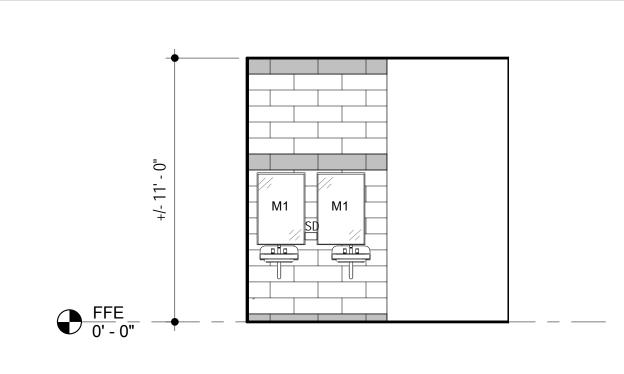


2 INTERIOR ELEVATION

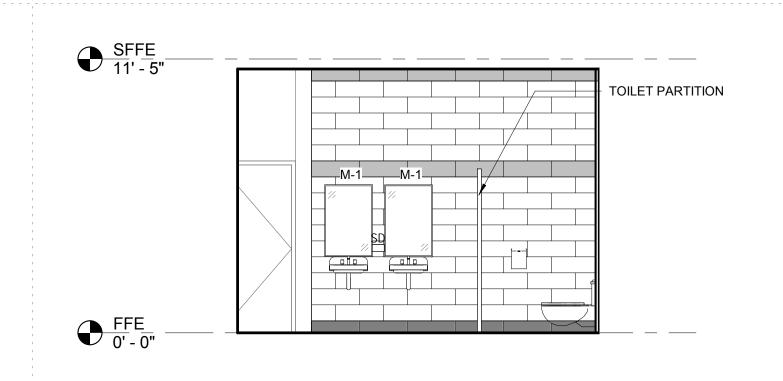


6 INTERIOR ELEVATION

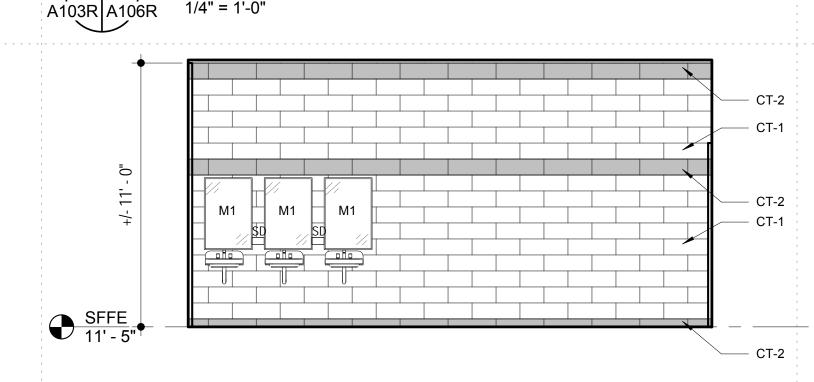


10 INTERIOR ELEVATION A103R A106R 1/4" = 1'-0"

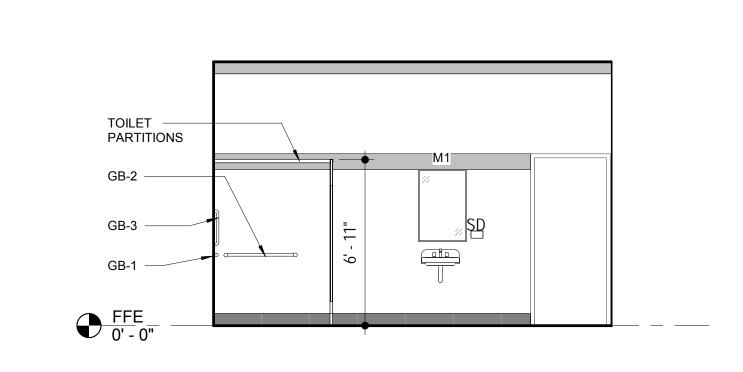


14 INTERIOR ELEVATION A103R A106R 1/4" = 1'-0"

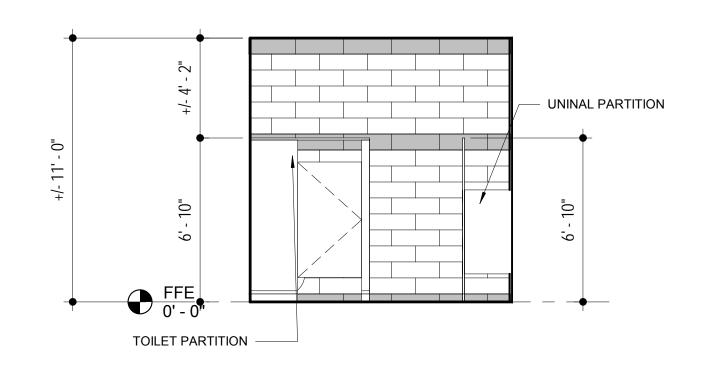


3 INTERIOR ELEVATION A103R A106R 1/4" = 1'-0"

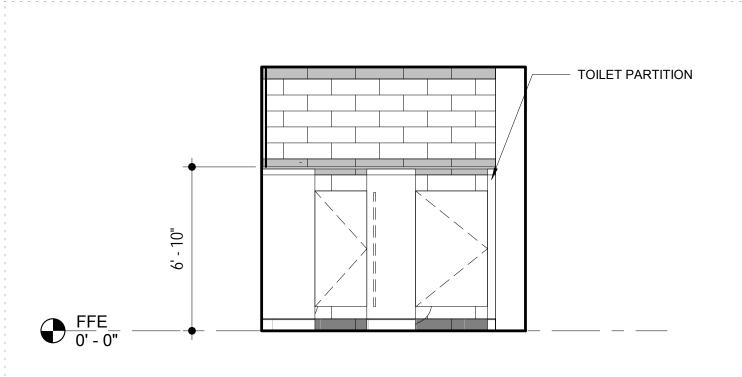


7 INTERIOR ELEVATION A103R A106R 1/4" = 1'-0"

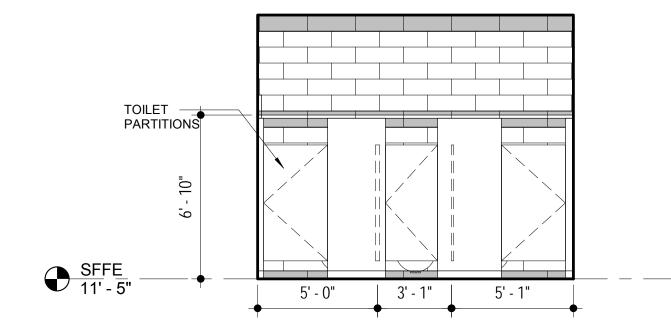


11 INTERIOR ELEVATION A103R A106R 1/4" = 1'-0"

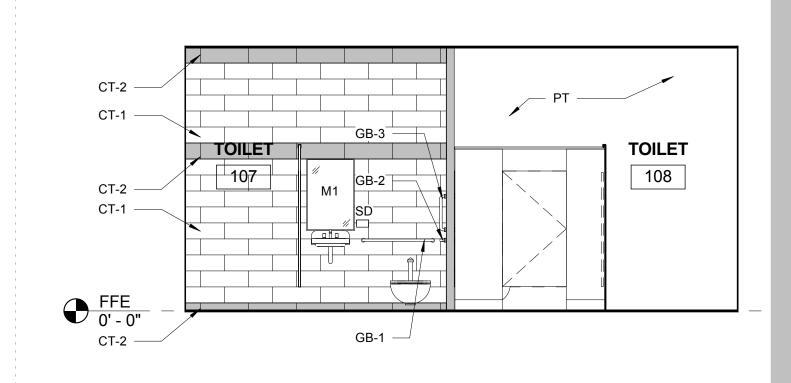

4 INTERIOR ELEVATION

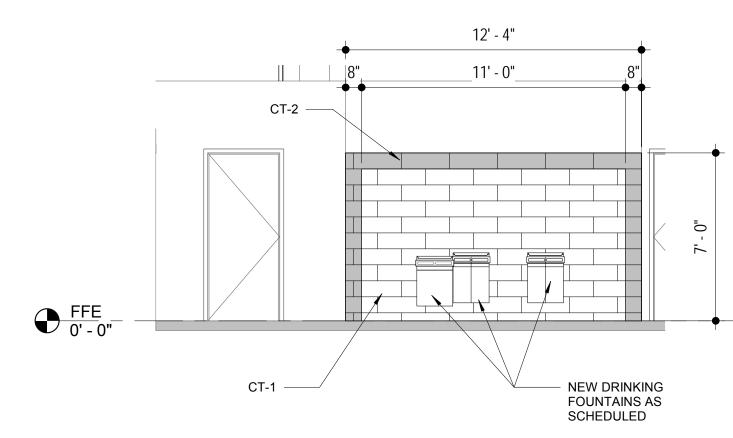

8 INTERIOR ELEVATION

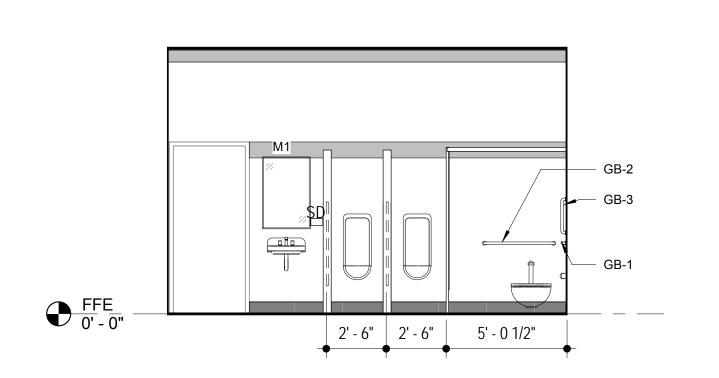

12 INTERIOR ELEVATION A103R A106R 1/4" = 1'-0"

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INTERIOR ELEVATIONS

Sheet Number 10 of 20

A106R

Original Plotted Sheet Size = 24"x36"

													nterior l	Finish So	chedule													
			Floor			Base		l	Jorth Wa	all	S	South Wall		East Wall			West Wall				Wainscot			Ceiling				
Room		Sub			Sub			Sub			Sub			Sub			Sub						Sub			Heigh	Comme	Room
Number	Room Name	Str	Fin.	Clr.	Str	Fin.	Clr.	Str	Fin.	Clr.	Str	Fin.	Clr.	Str	Fin.	Clr.	Str	Fin	Clr.	Fin	Clr	Height	Str	Fin.	Clr.	t	nts	Number
101	TOILET	EX TILE	EPOXY	1	EX CMU	СТ	2	EX CMU	PT	1	EX CMU	PT, CT	1,1	EX CMU	PT, CT	1,1	EX CMU	PT, CT	1, 1				EX DECKING	PT	3			101
102	TOILET	EX TILE	EPOXY	1	EX CMU	СТ	2	EX CMU	PT	1	EX CMU	PT, CT	1,1	EX CMU	PT, CT	1,1	EX CMU	PT, CT	1, 1				EX DECKING	PT	3			102
103	TOILET	EX TILE	EPOXY	1	EX CMU	СТ	2	EX CMU	PT	1	EX CMU	PT, CT	1,1	EX CMU	PT, CT	1,1	EX CMU	PT, CT	1, 1				EX DECKING	PT	3			103
104	TOILET	EX TILE	EPOXY	1	EX CMU	СТ	2	EX CMU	PT	1	EX CMU	PT, CT	1,1	EX CMU	PT, CT	1,1	EX CMU	PT, CT	1, 1				EX DECKING	PT	3			104
	TOILET	EX TILE		1	EX CMU	СТ	2	EX CMU	PT	1	EX CMU	PT, CT	1,1	EX CMU	PT, CT	1,1	EX CMU	PT, CT	1, 1				EX DECKING	PT	3			105
	TOILET	EX TILE		1	EX CMU	СТ	2	EX CMU	PT	1	EX CMU	PT, CT	1,1	EX CMU	PT, CT	1,1	EX CMU	PT, CT	1, 1				EX DECKING	PT	3			106
	TOILET	EX TILE		1	EX CMU	СТ	2	EX CMU	PT	1	EX CMU	PT, CT	1,1	EX CMU	PT, CT	1,1	EX CMU	PT, CT	1, 1				EX DECKING	PT	3			107
	TOILET	EX TILE		1	EX CMU	СТ	2	EX CMU	PT	1	EX CMU	PT, CT	1,1	EX CMU	PT, CT	1,1	EX CMU	PT, CT	1, 1				EX DECKING	PT	3			108
	TOILET	EX TILE		1	EX CMU	СТ	2	EX CMU	PT	1	EX CMU	PT, CT	1,1	EX CMU	PT, CT	1,1	EX CMU	PT, CT	1, 1				EX DECKING	PT	3			109
110	GIRL LOCKER ROOM	EX TILE	EPOXY	1	EX CMU	СТ	2	EX CMU	PT	1	EX CMU	PT, CT	1,1	EX CMU	PT, CT	1,1	EX CMU	PT, CT	1, 1				EX DECKING	PT	3			110
	BOYS LOCKER ROOM	EX TILE	EPOXY	1	EX CMU	СТ	2	EX CMU	PT	1	EX CMU	PT, CT	1,1	EX CMU	PT, CT	1,1	EX CMU	PT, CT	1, 1				EX DECKING	PT	3			111
201	TOILET	EX TILE	EPOXY	1	EX CMU	СТ	2	EX CMU	PT	1	EX CMU	PT, CT	1,1	EX CMU	PT, CT	1,1	EX CMU	PT, CT	1, 1				EX DECKING	PT	3			201
202	TOILET	EX TILE	EPOXY	1	EX CMU	СТ	2	EX CMU	PT	1	EX CMU	PT, CT	1,1	EX CMU	PT, CT	1,1	EX CMU	PT, CT	1, 1				EX DECKING	PT	3			202
203	TOILET	EX TILE	EPOXY	1	EX CMU	СТ	2	EX CMU	PT	1	EX CMU	PT, CT	1,1	EX CMU	PT, CT	1,1	EX CMU	PT, CT	1, 1				EX DECKING	PT	3			203
204	TOILET	EX TILE	EPOXY	1	EX CMU	СТ	2	EX CMU	PT	1	EX CMU	PT, CT	1,1	EX CMU	PT, CT	1,1	EX CMU	PT, CT	1, 1				EX DECKING	PT	3			204

FOR FINISH SCHEDULE, PLAN NORTH IS UPSHEET

EXOPY-1 DUR-A-FLEX : DUR-A-QUARTZ COLOR: Q28-23 VCT ARMSTRONG FLOORING: VINYL COMPOSITION TILE

STYLE: STANDARD EXCELON COLOR: 51947 BASIL GREEN MATERIAL:

WALLS:

CT-1 CROSSVILLE- 12"x24"

SERIES: READY TO WEAR; COLOR: PERFECT FIT

CT-2 CROSSVILLE- 6"x24" SERIES: READY TO WEAR; COLOR: DECKED OUT

SHERWIN WILLIAMS PAINT - WALLS COLOR: SW 9165 GOSSAMER VEIL

SHERWIN WILLIAMS PAINT - ACCENT COLOR: SW 6181 SECRET GARDEN PT-3

SHERWIN WILLIAMS PAINT - FURRDOWN COLOR: SW 6203 SPARE WHITE

<u>CEILINGS:</u>

PT-3 SHERWIN WILLIAMS PAINT - WALLS

COLOR: SW 6203 SPARE WHITE

MARK: MATERIAL:

MILLWORK:

PLAM-1 FORMICA PLASTIC LAMINATE- BASE COLOR: 8839-58 ASHEN RIBBONWOOD

PLAM-2 FORMICA PLASTIC LAMINATE- BASE COLOR: 934-58 PEARL

SS-1 FORMICA CLASSICS- SOLID SURFACE

COLOR:LUNA CONCRETE 781

TOILET PARTITION BRADLEY- FLOOR TO OVERHEAD BRACED: SOLID COLOR REINFORCED COMPOSITE COLOR: CHARCOAL GRAY(S215)

GENERAL NOTES:

A. EXISTING RUBBER BASE IS TO REMAIN AND MODIFIED AS REQUIRED TO INSTALL NEW WORK. IN INSTANTS WHERE THE BASE NEED REPLACING, GC IS TO PROVIDE NEW RUBBER THAT MATCHES THE EXISTING IN COLOR AND DESIGN. PRODUCT IS TO BE SUBMITTAL THE REQUIREMENTS IN THE SPECIFICATIONS.

B. PROVIDE (16) 8"x8" TOILET SIGNS

C. ALL FURR DOWN SHALL BE PAINTED PT-3 UNLESS OTHERWISE NOTED.

D. REFER TO INTERIOR ELEVATIONS, AND MILLWORK ELEVATIONS AND DETAILS FOR ADDITIONAL INFORMATION

E. ON THE INSIDE OF THE RESTROOM, ALL HOLLOW METAL DOOR FRAMES ARE TO BE PAINTED PT-2


F. WALL ACCESS DOORS ARE TO BE PAINTED. COLOR TO MATCH THE ADJACENT WALL COLOR.

COMMENTS:


1. ALLOW FOR ACCENT WALL TILES IN ROOM. SEE INTERIOR ELEVATIONS.


2. ALLOW FOR ACCENT STRIPE/BAND IN THIS AREA.

3. SEE PLAN FOR ACCENT WALL LOCATION.

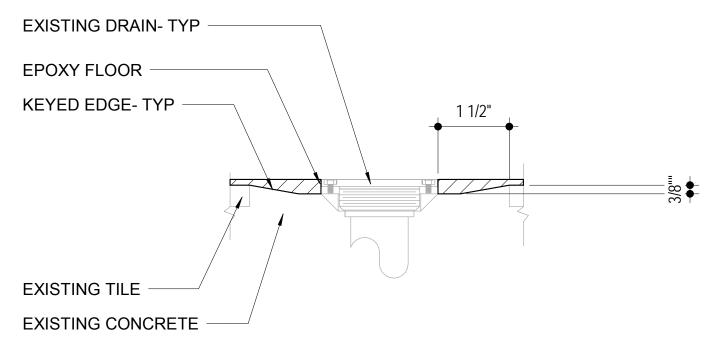


EPOXY FLOORING DRAIN DETAIL-TYP 6" = 1'-0"

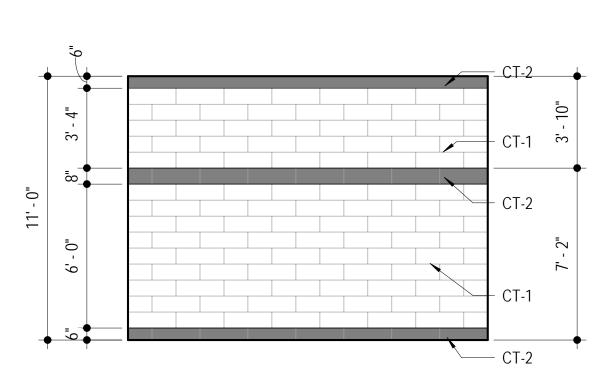

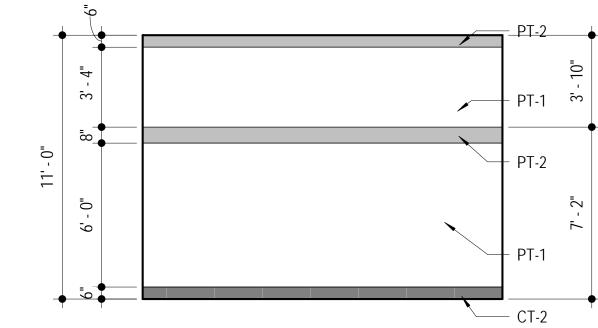


TYP TILE WALL ELEVATION \A107R 1/4" = 1'-0"



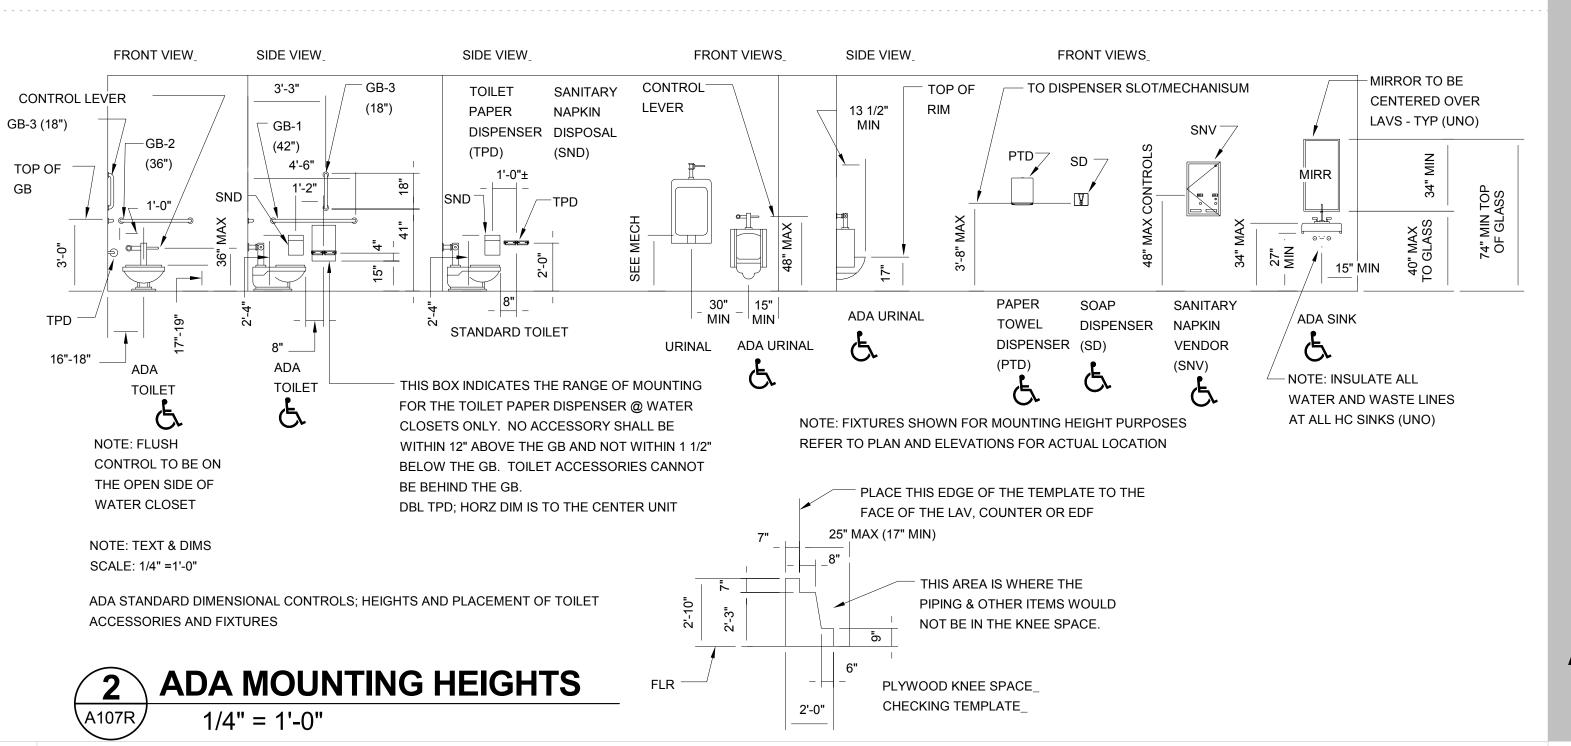

Greg L. Durrell, AIA

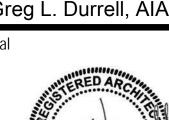



RESTROOM IMPROVEMENTS HOOL

Project 19.002 Number: Date: Drawn by: Checked by: Revisions 1/15/2020


FINISH

SCHEDULE

Sheet Title

Sheet Number 11 of 20

A107R

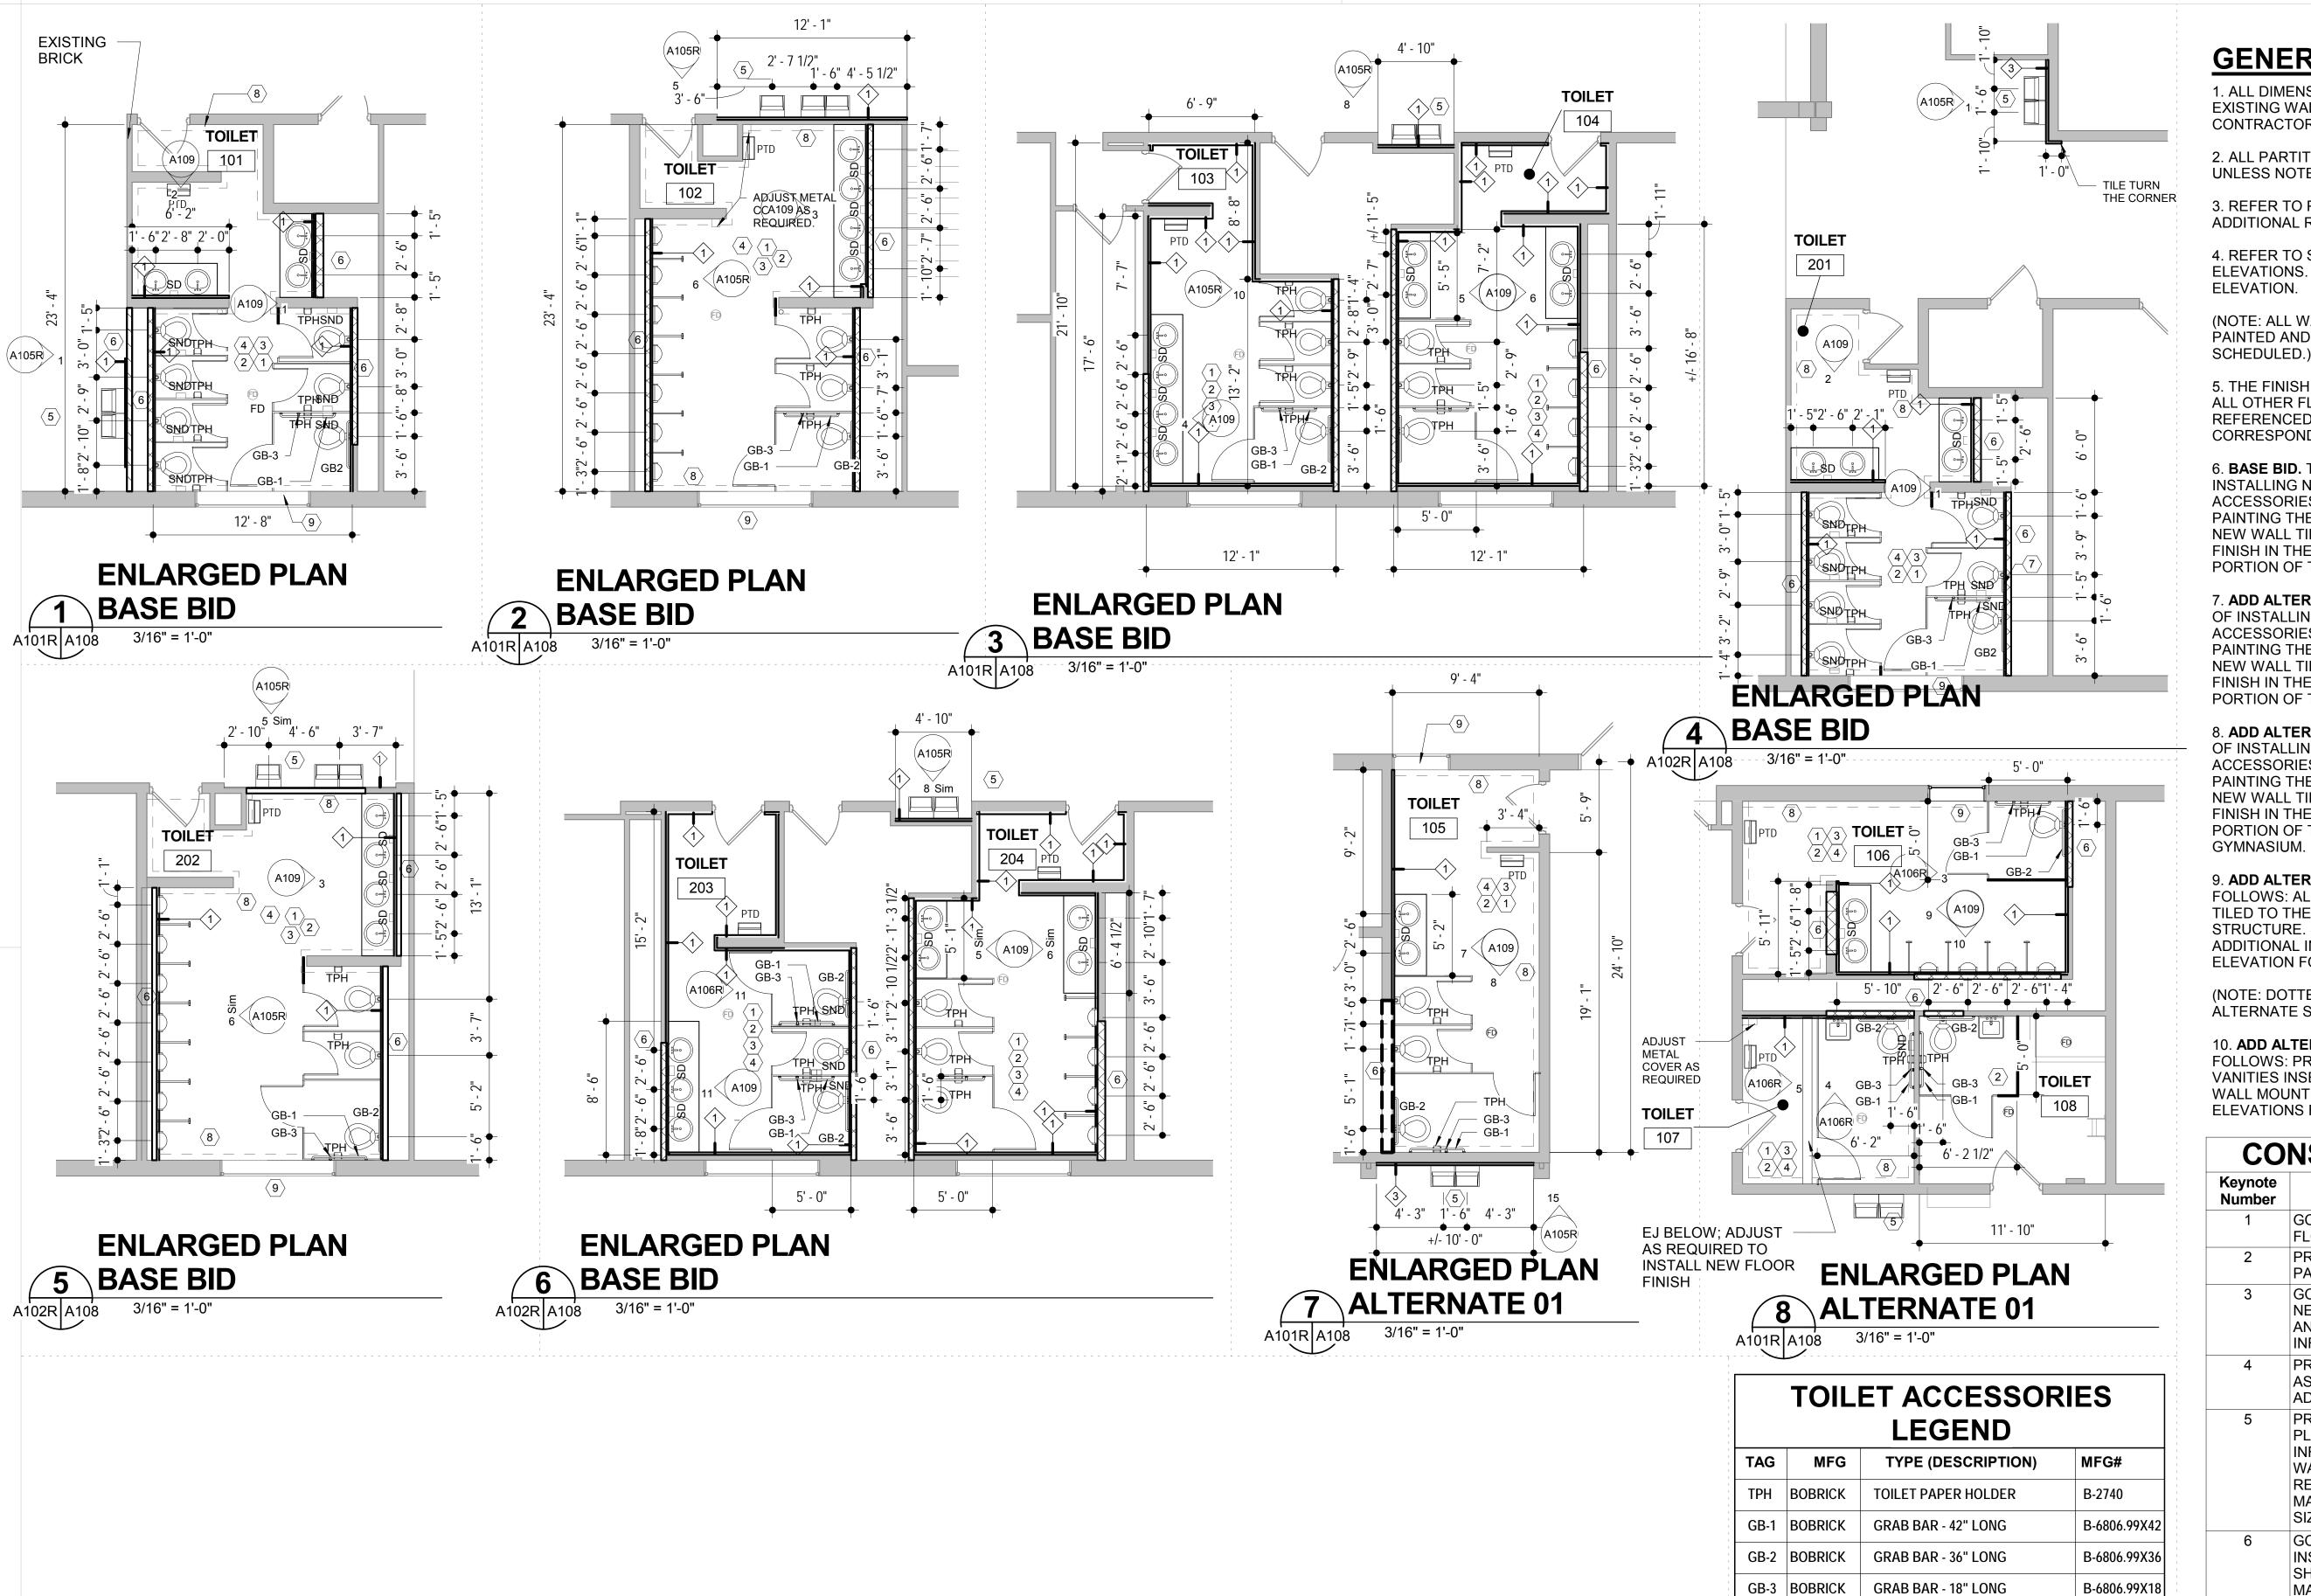

GENERAL NOTES:

1. ALL DIMENSIONS ARE TO THE OUTSIDE FACE OF EXISTING WALL UNLESS NOTED OTHERWISE CONTRACTOR IS TO FIELD VERIFY ALL DIMENSIONS

2. ALL PARTITIONS ARE TO EXTEND TO THE DECK UNLESS NOTED OTHERWISE.

3. REFER TO PLUMBING AND ELECTRICAL SHEETS FOR ADDITIONAL REQUIREMENTS.

4. REFER TO SHEETS A105-A107 FOR INTERIOR ELEVATIONS. SEE SHEET A107 FOR TYPICAL TILE ELEVATION.

(NOTE: ALL WALLS NOT RECEIVING TILES ARE TO BE PAINTED AND NEW ELECTRICAL COVER PLATES AS

5. THE FINISH FLOOR WILL BE REFERENCED AS 0'-0" AND ALL OTHER FLOOR ELEVATIONS, CEILINGS, ETC. WILL BE REFERENCED FROM THAT ELEVATION OR CORRESPONDING LEVEL

6. BASE BID. THE SCOPE OF WORK CONSISTS OF INSTALLING NEW PLUMBING FIXTURES, TOILET ACCESSORIES, NEW WALL TILE ON THE WET WALLS, PAINTING THE EXISTING WALL THAT DOES NOT RECEIVE NEW WALL TILE, LIGHT FIXTURES, AND NEW FLOOR FINISH IN THE RESTROOM AREA FOR THE 2 STORY PORTION OF THE BUILDING DESIGNATED AS WING 1.

7. ADD ALTERNATE 01. THE SCOPE OF WORK CONSISTS OF INSTALLING NEW PLUMBING FIXTURES, TOILET ACCESSORIES, NEW WALL TILE ON THE WET WALLS, PAINTING THE EXISTING WALL THAT DOES NOT RECEIVE NEW WALL TILE, LIGHT FIXTURES, AND NEW FLOOR FINISH IN THE RESTROOM AREA FOR THE 1 STORY PORTION OF THE BUILDING DESIGNATED AS WING 2.

8. ADD ALTERNATE 02. THE SCOPE OF WORK CONSISTS OF INSTALLING NEW PLUMBING FIXTURES, TOILET ACCESSORIES, NEW WALL TILE ON THE WET WALLS, PAINTING THE EXISTING WALL THAT DOES NOT RECEIVE NEW WALL TILE, LIGHT FIXTURES, AND NEW FLOOR FINISH IN THE RESTROOM AREA FOR THE 1 STORY PORTION OF THE BUILDING LOCATED BEHIND THE GYMNASIUM.

9. ADD ALTERNATE 03. THE SCOPE OF WORK IS AS FOLLOWS: ALL WALLS IN THE RESTROOMS ARE TO BE TILED TO THE HEIGHT OF EXISTING DECK OR STRUCTURE. SEE ALTERNATE ELEVATION FOR ADDITIONAL INFORMATION. REFER TO TYPICAL TILE ELEVATION FOR TILE LAYOUT.

(NOTE: DOTTED LINES ON PLANS INDICATES THE ALTERNATE SCOPE OF WORK.)

10. **ADD ALTERNATE 04.** THE SCOPE OF WORK IS AS FOLLOWS: PROVIDE MILLWORK AND COUNTERS WITH VANITIES INSERT AS SCHEDULED IN LIEU OF SINGLE WALL MOUNTED VANITIES. SEE ALTERNATE PLANS AND ELEVATIONS FOR ADDITIONAL INFORMATION.

CONSTRUCTION NOTES

Keynote Number	Description
1	GC TO PREP EXISTING FLOOR FOR NEW FLOOR FINISH.
2	PROVIDE NEW URINAL AND TOILET PARTITIONS.
3	GC TO REPAIR AND PREP WALL TO RECEIVE NEW FINISH. COORDINATE WITH PLUMBING AND ELECTRICAL SHEETS FOR ADDITIONAL INFORMATION.
4	PREP AND PAINT EXISTING CEILING. COLOR AS SCHEDULED. SEE SHEET A104 FOR ADDITIONAL INFORMATION.
5	PROVIDE NEW DRINKING FOUNTION. SEE PLUMBING DRAWINGS FOR ADDITIONAL INFORMATION. GC TO PATCH AND REPAIR WALL / FLOOR AS REQUIRED. ON FLOOR REPAIR PROVIDE NEW VCT MATERIAL IS TO MATCH THE ADJACENT FLOOR FINISH IN SIZE AND COLOR.
6	GC TO MODIFY THE WALL AS REQUIRED TO INSTALL NEW FIXTURE COMPONENTS. GC SHALL INSTALL NEW MATERIAL THAT MATCHES THE ADJACENT WALL MATERIAL UNLESS OTHERWISE NOTED. GC SHALL COORDINATE THE INSTALLATION OF NEW COMPONETS WITH THE PLUMBING DRAWINGS.
7	WALL DRAIN TO REMAIN. MODIFY AS REQUIRED TO INSTALL NEW WORK. SEE PLUMBING FOR ADDITIONAL INFORMATION.
8	ADD ALTERNATE. PROVIDE NEW WALL TILE UP TOEXISTING DECK OR STRUCTURE.
9	ADD ALTERNATE. PROVIDE NEW TILE IN WINDOW JAMB AND HEAD. PROVIDE SS-1 IN THE SILL. SS-1 TO OVER HANG WALL TILE BY 1".

B-169

B-262

B-2112

B-270

MIRROR - 24" X 36"

BOBRICK PAPER TOWEL DISPENSER

SOAP DISPENSER

SANITARY NAPKIN DISPOSAL

BOBRICK

BOBRICK

SND BOBRICK

SD

3/16" = 1'-0"

A108

Original Plotted Sheet Size = 24"x36"

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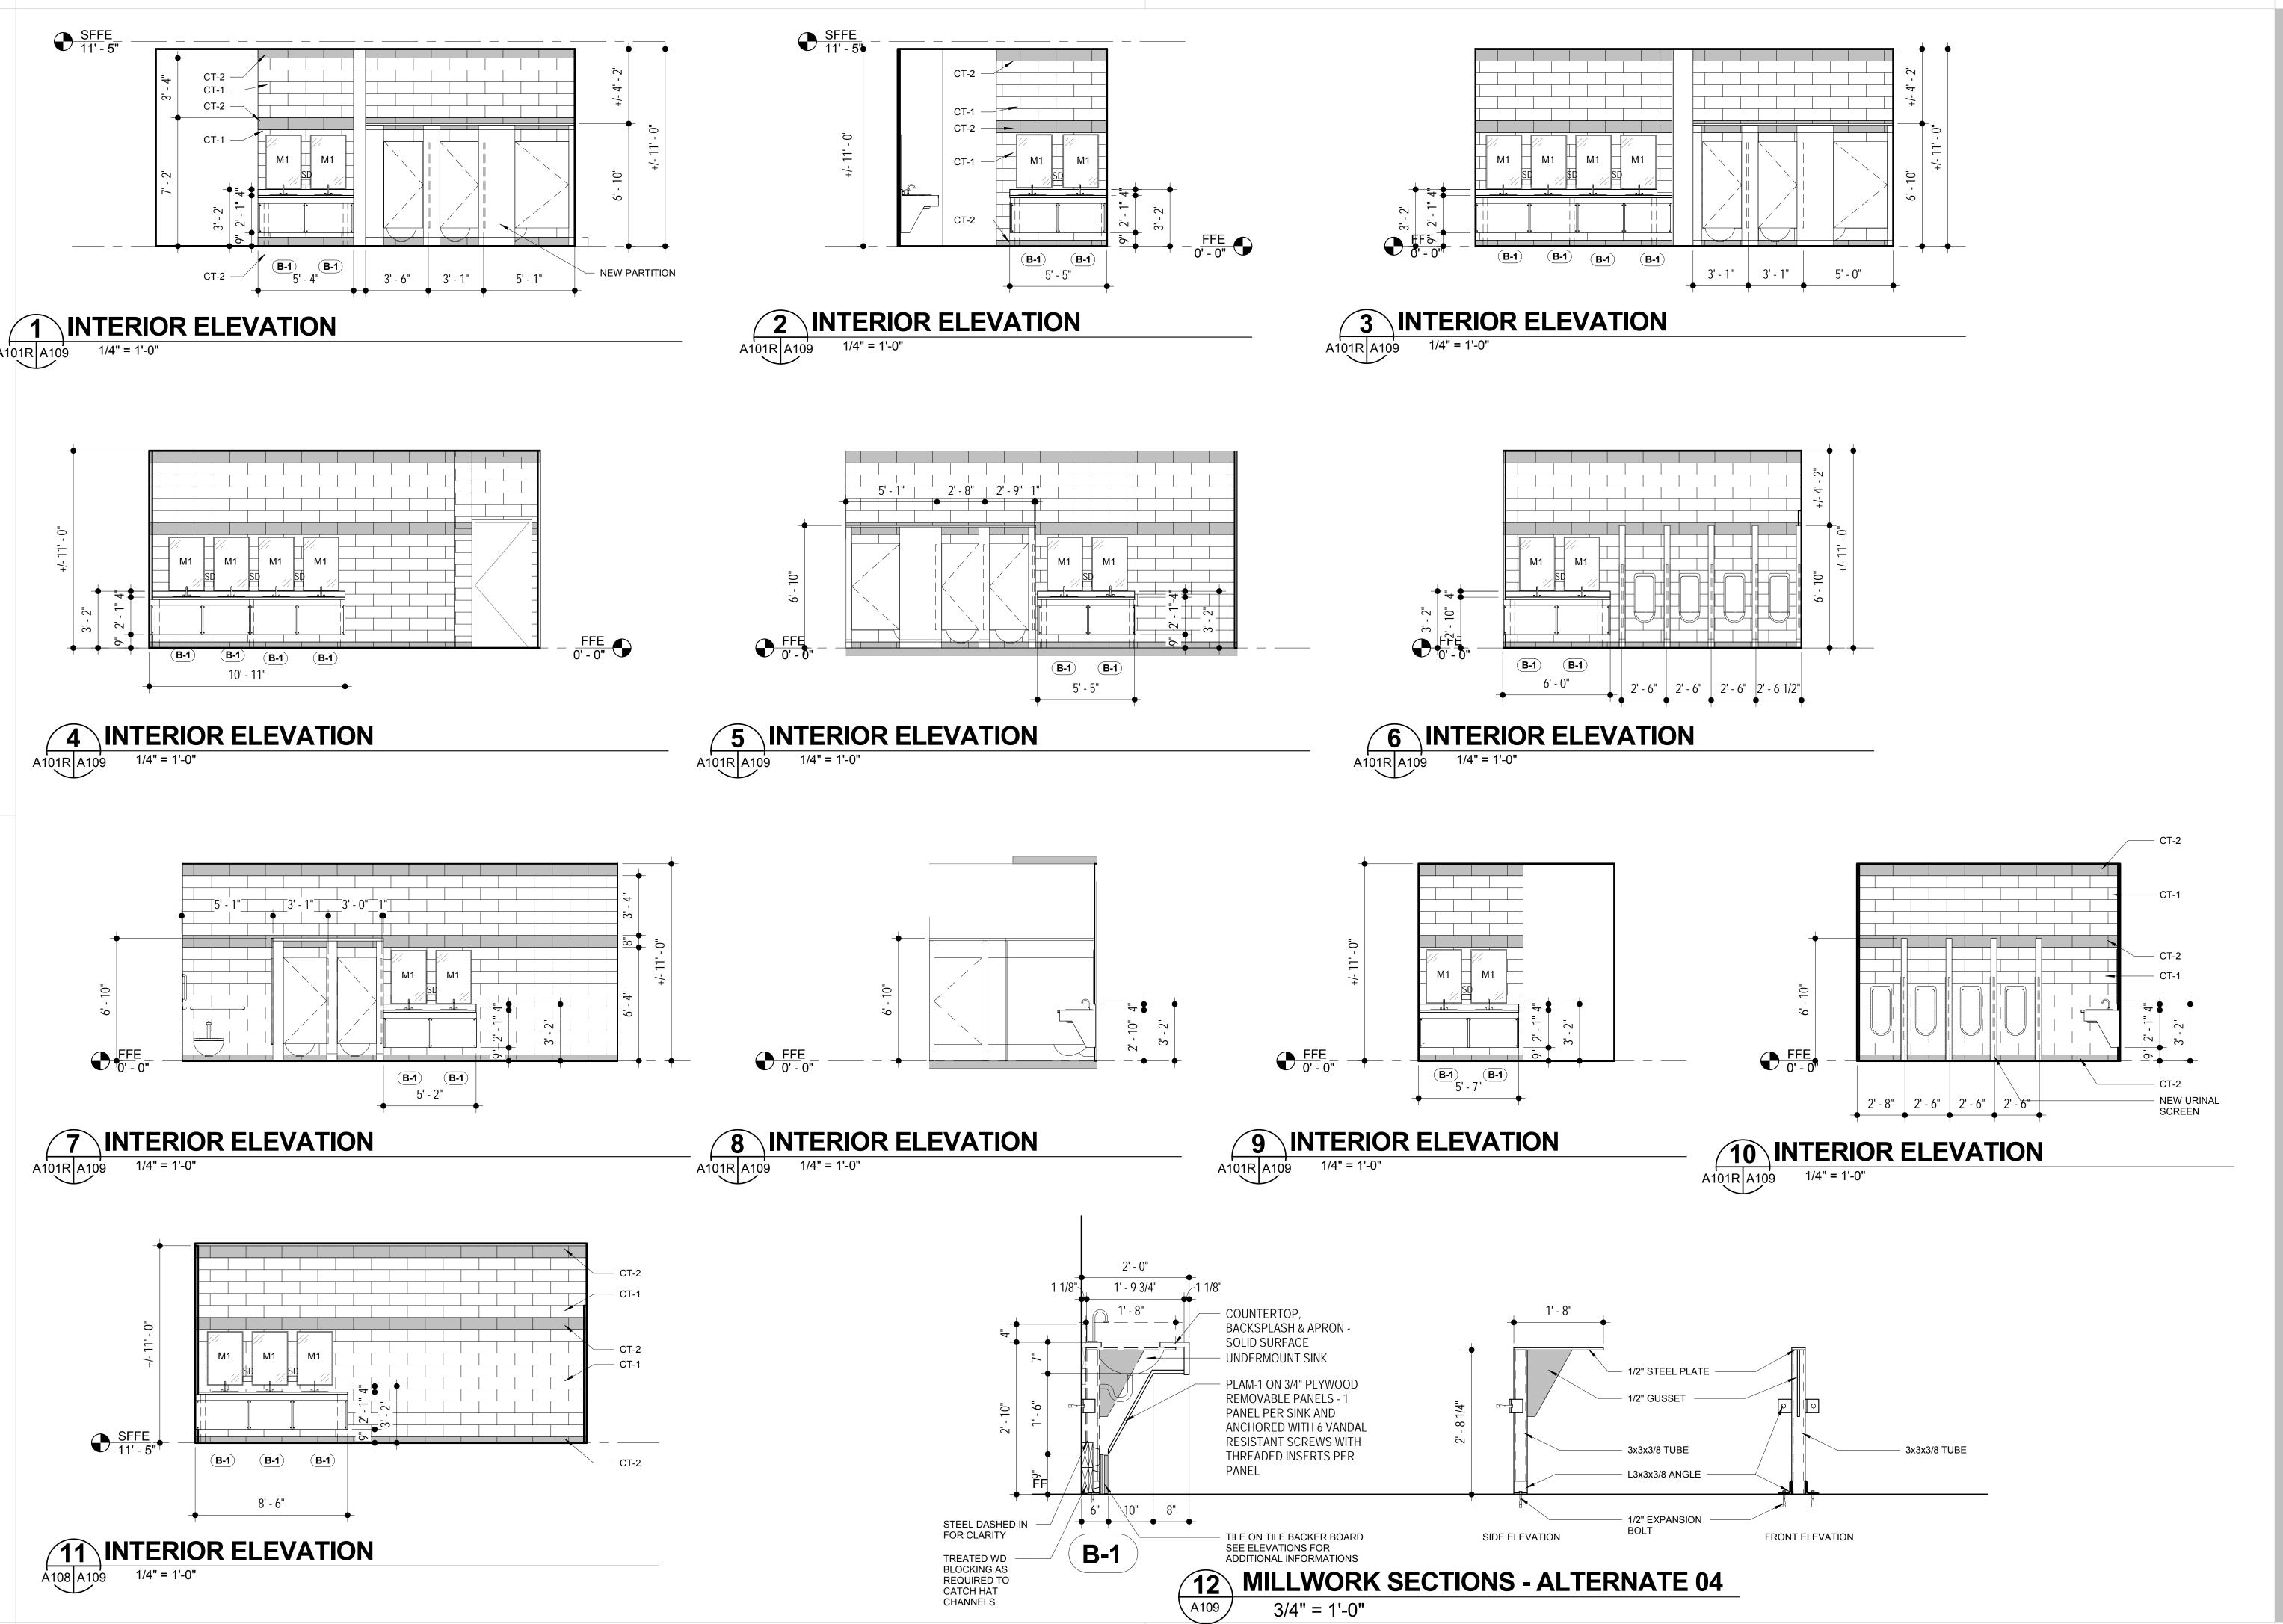
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2018 BOND PROJECT: R
FOR JIM HILL HIGH SCH
JACKSON PUBLIC SCHO Project 19.002 Number: 02.DEC.2019 Date: Drawn by:

GD Checked by: Revisions 1/15/2020

Sheet Title RENOVATION

ENLARGED PLANS TOILETS (ALTERNATE 04)

Sheet NumbeDesignerof 20



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T: RESTROOM IMPROVEMENTS CHOOL

2018 BOND PROJECT: R FOR JIM HILL HIGH SCH JACKSON PUBLIC SCHC

Project 19.002 Number: 02.DEC.2019

Date: Drawn by:

Checked by: Revisions


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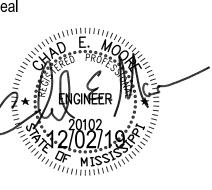
INTERIOR **ELEVATION** (ALTERNATE 04)

Sheet Number . of 20

A109




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FIRST FLOOR **RENOVATIONS**

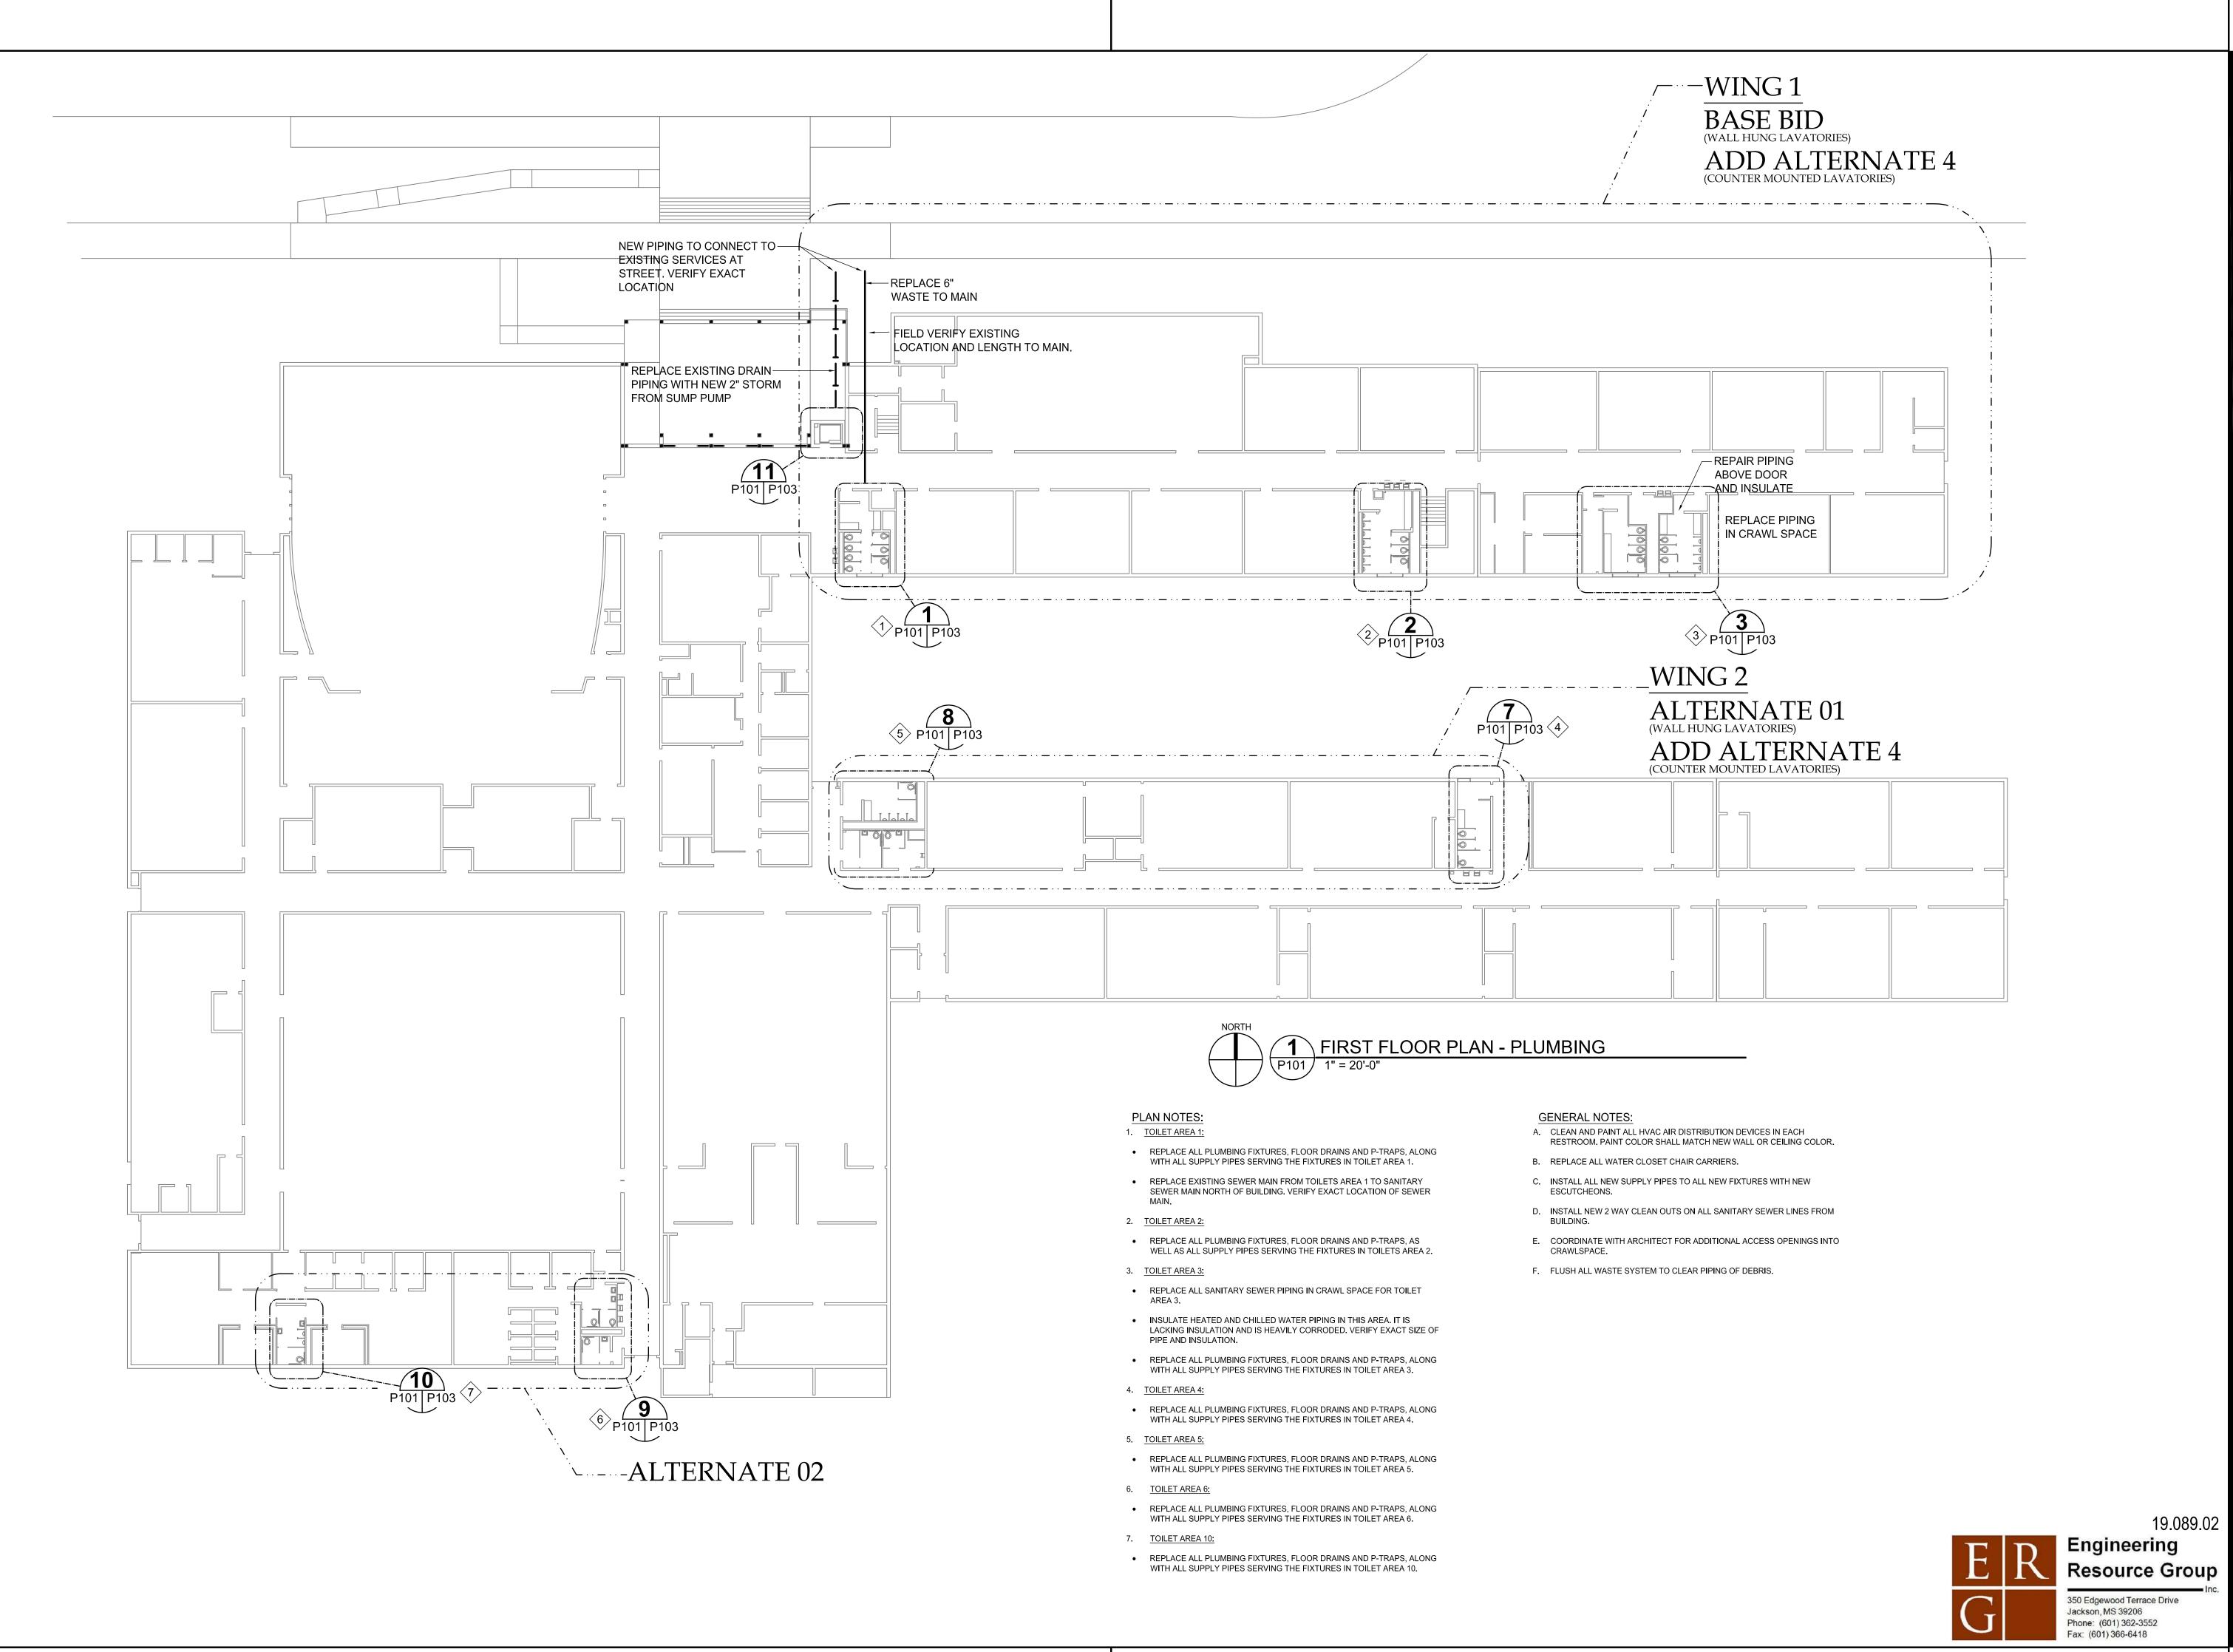Sheet Number . of

19.089.02



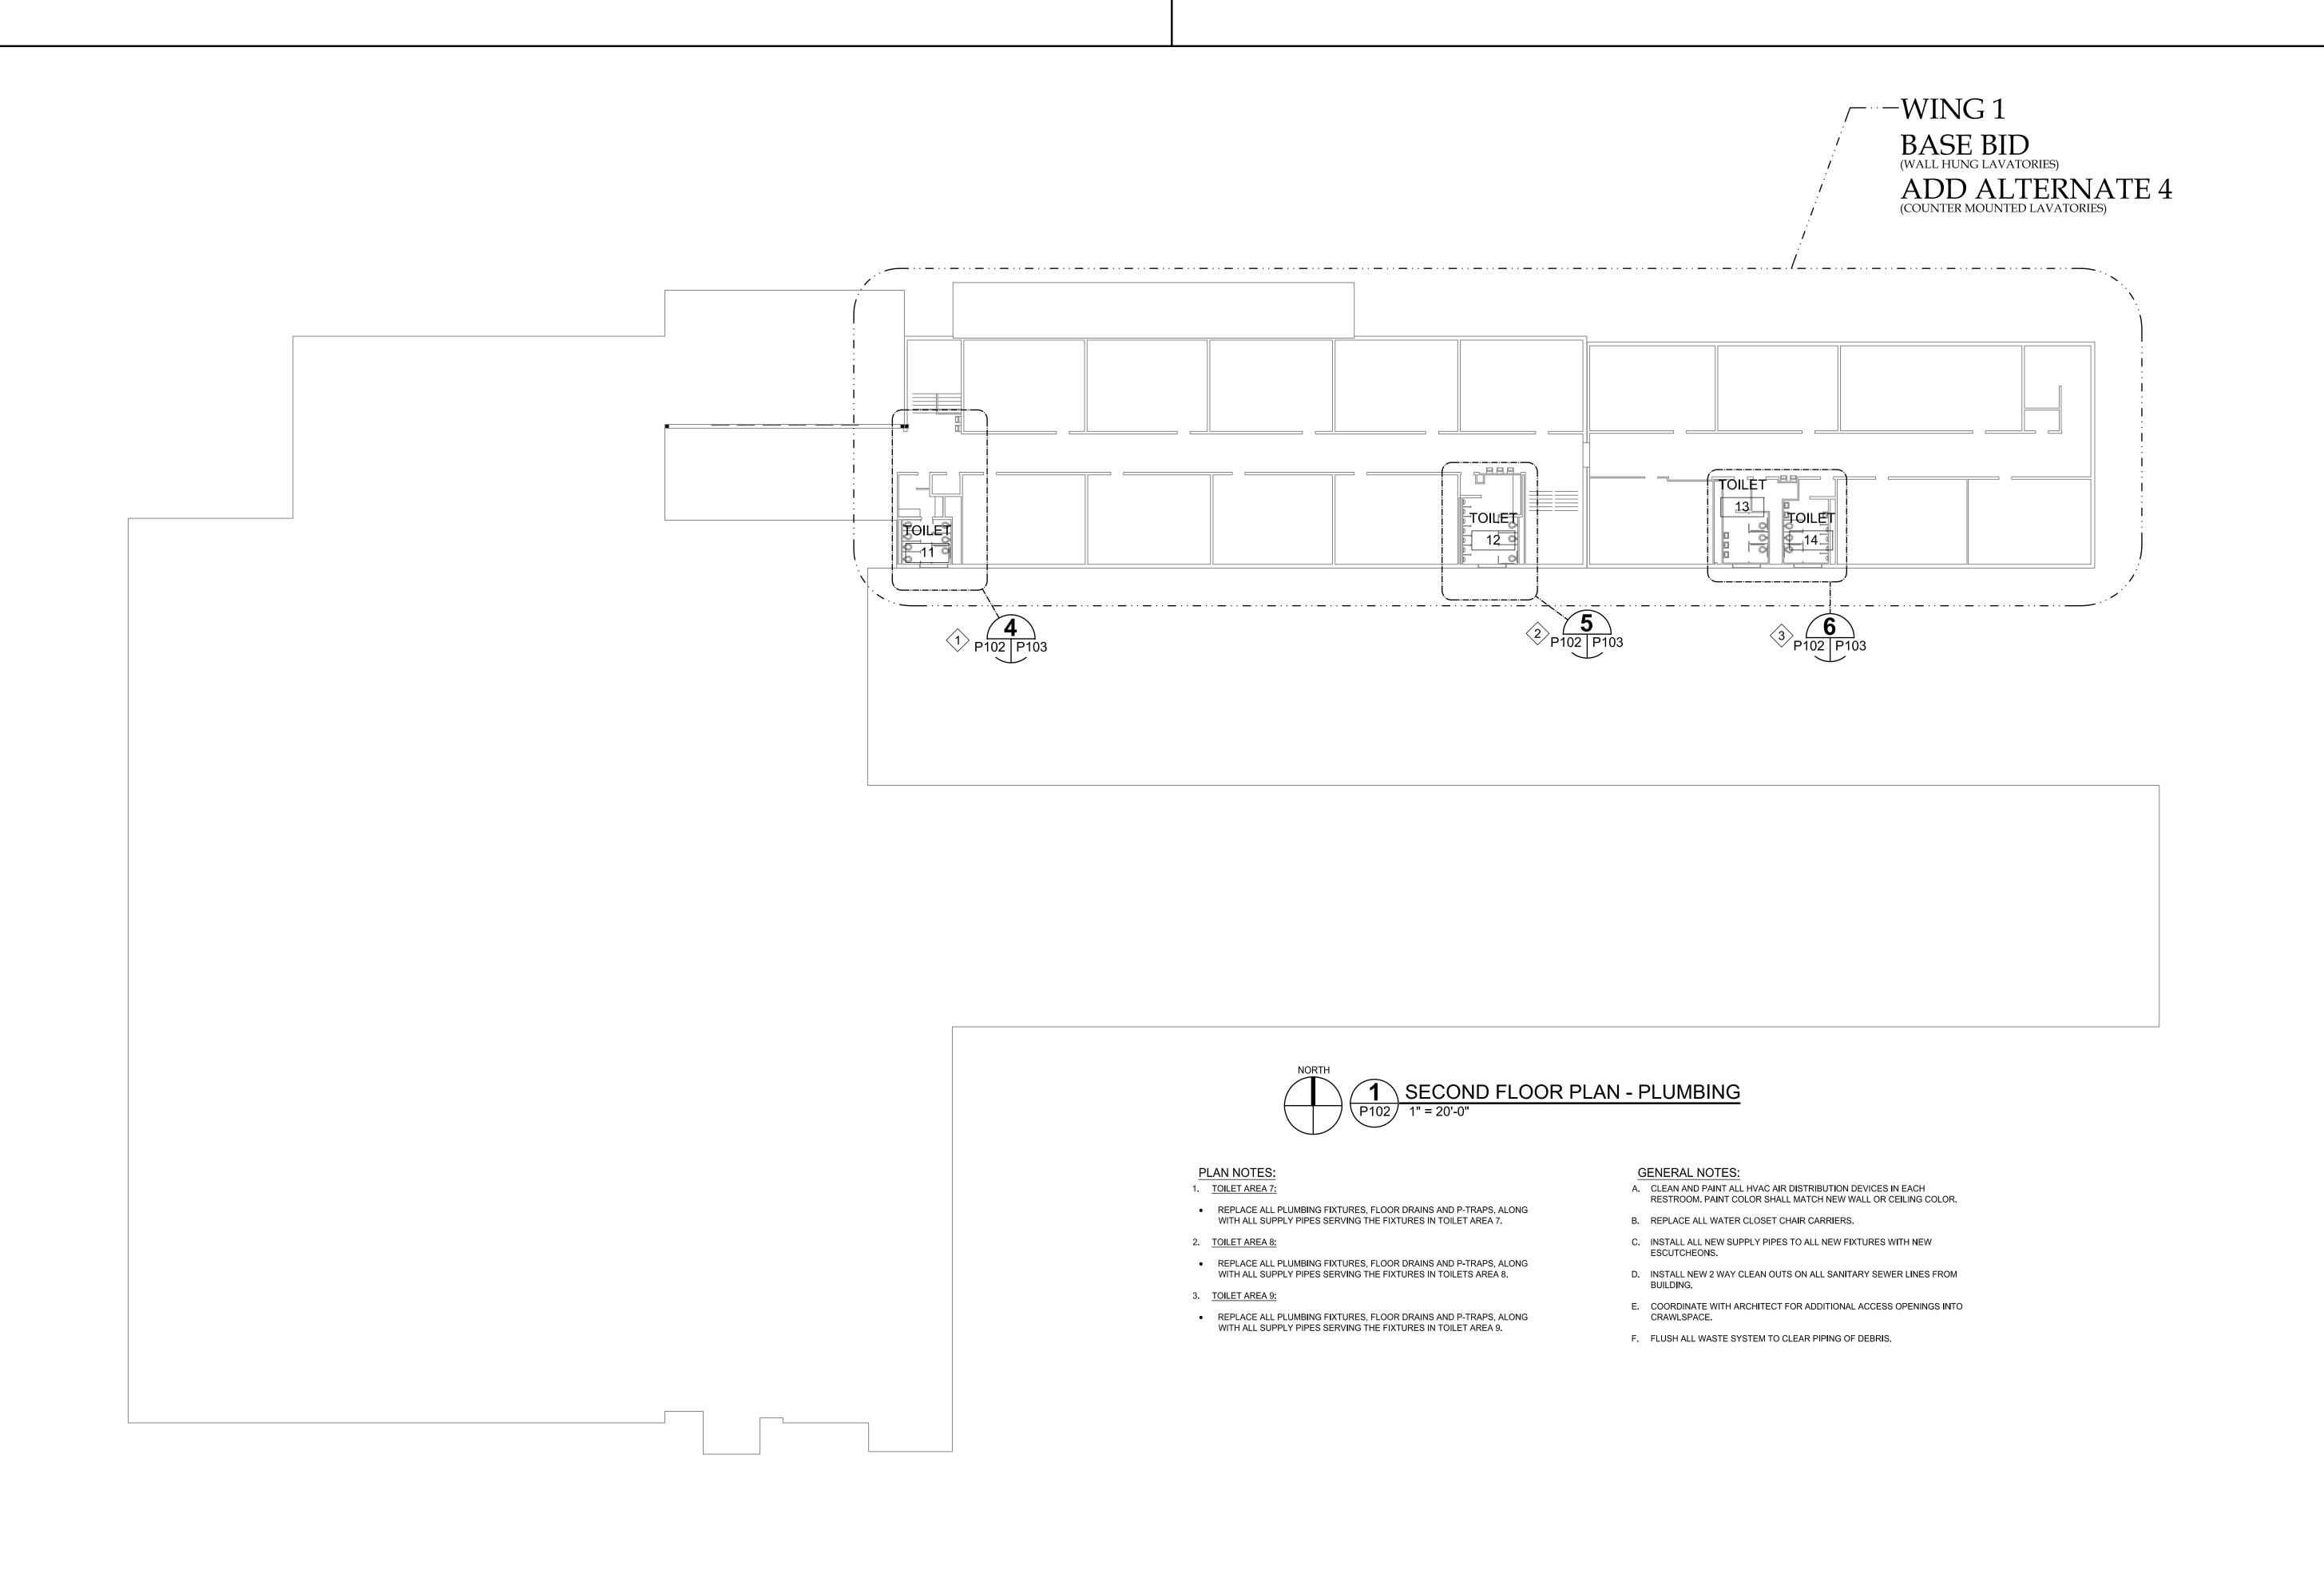


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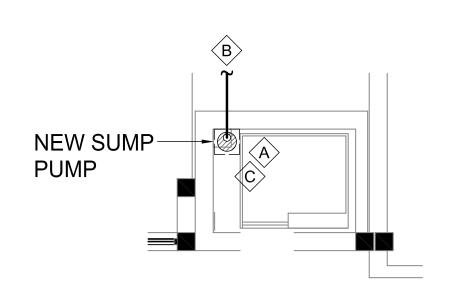
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JL IMPROVEMENTS HOOLS

SECOND FLOOR RENOVATIONS

Sheet Number of



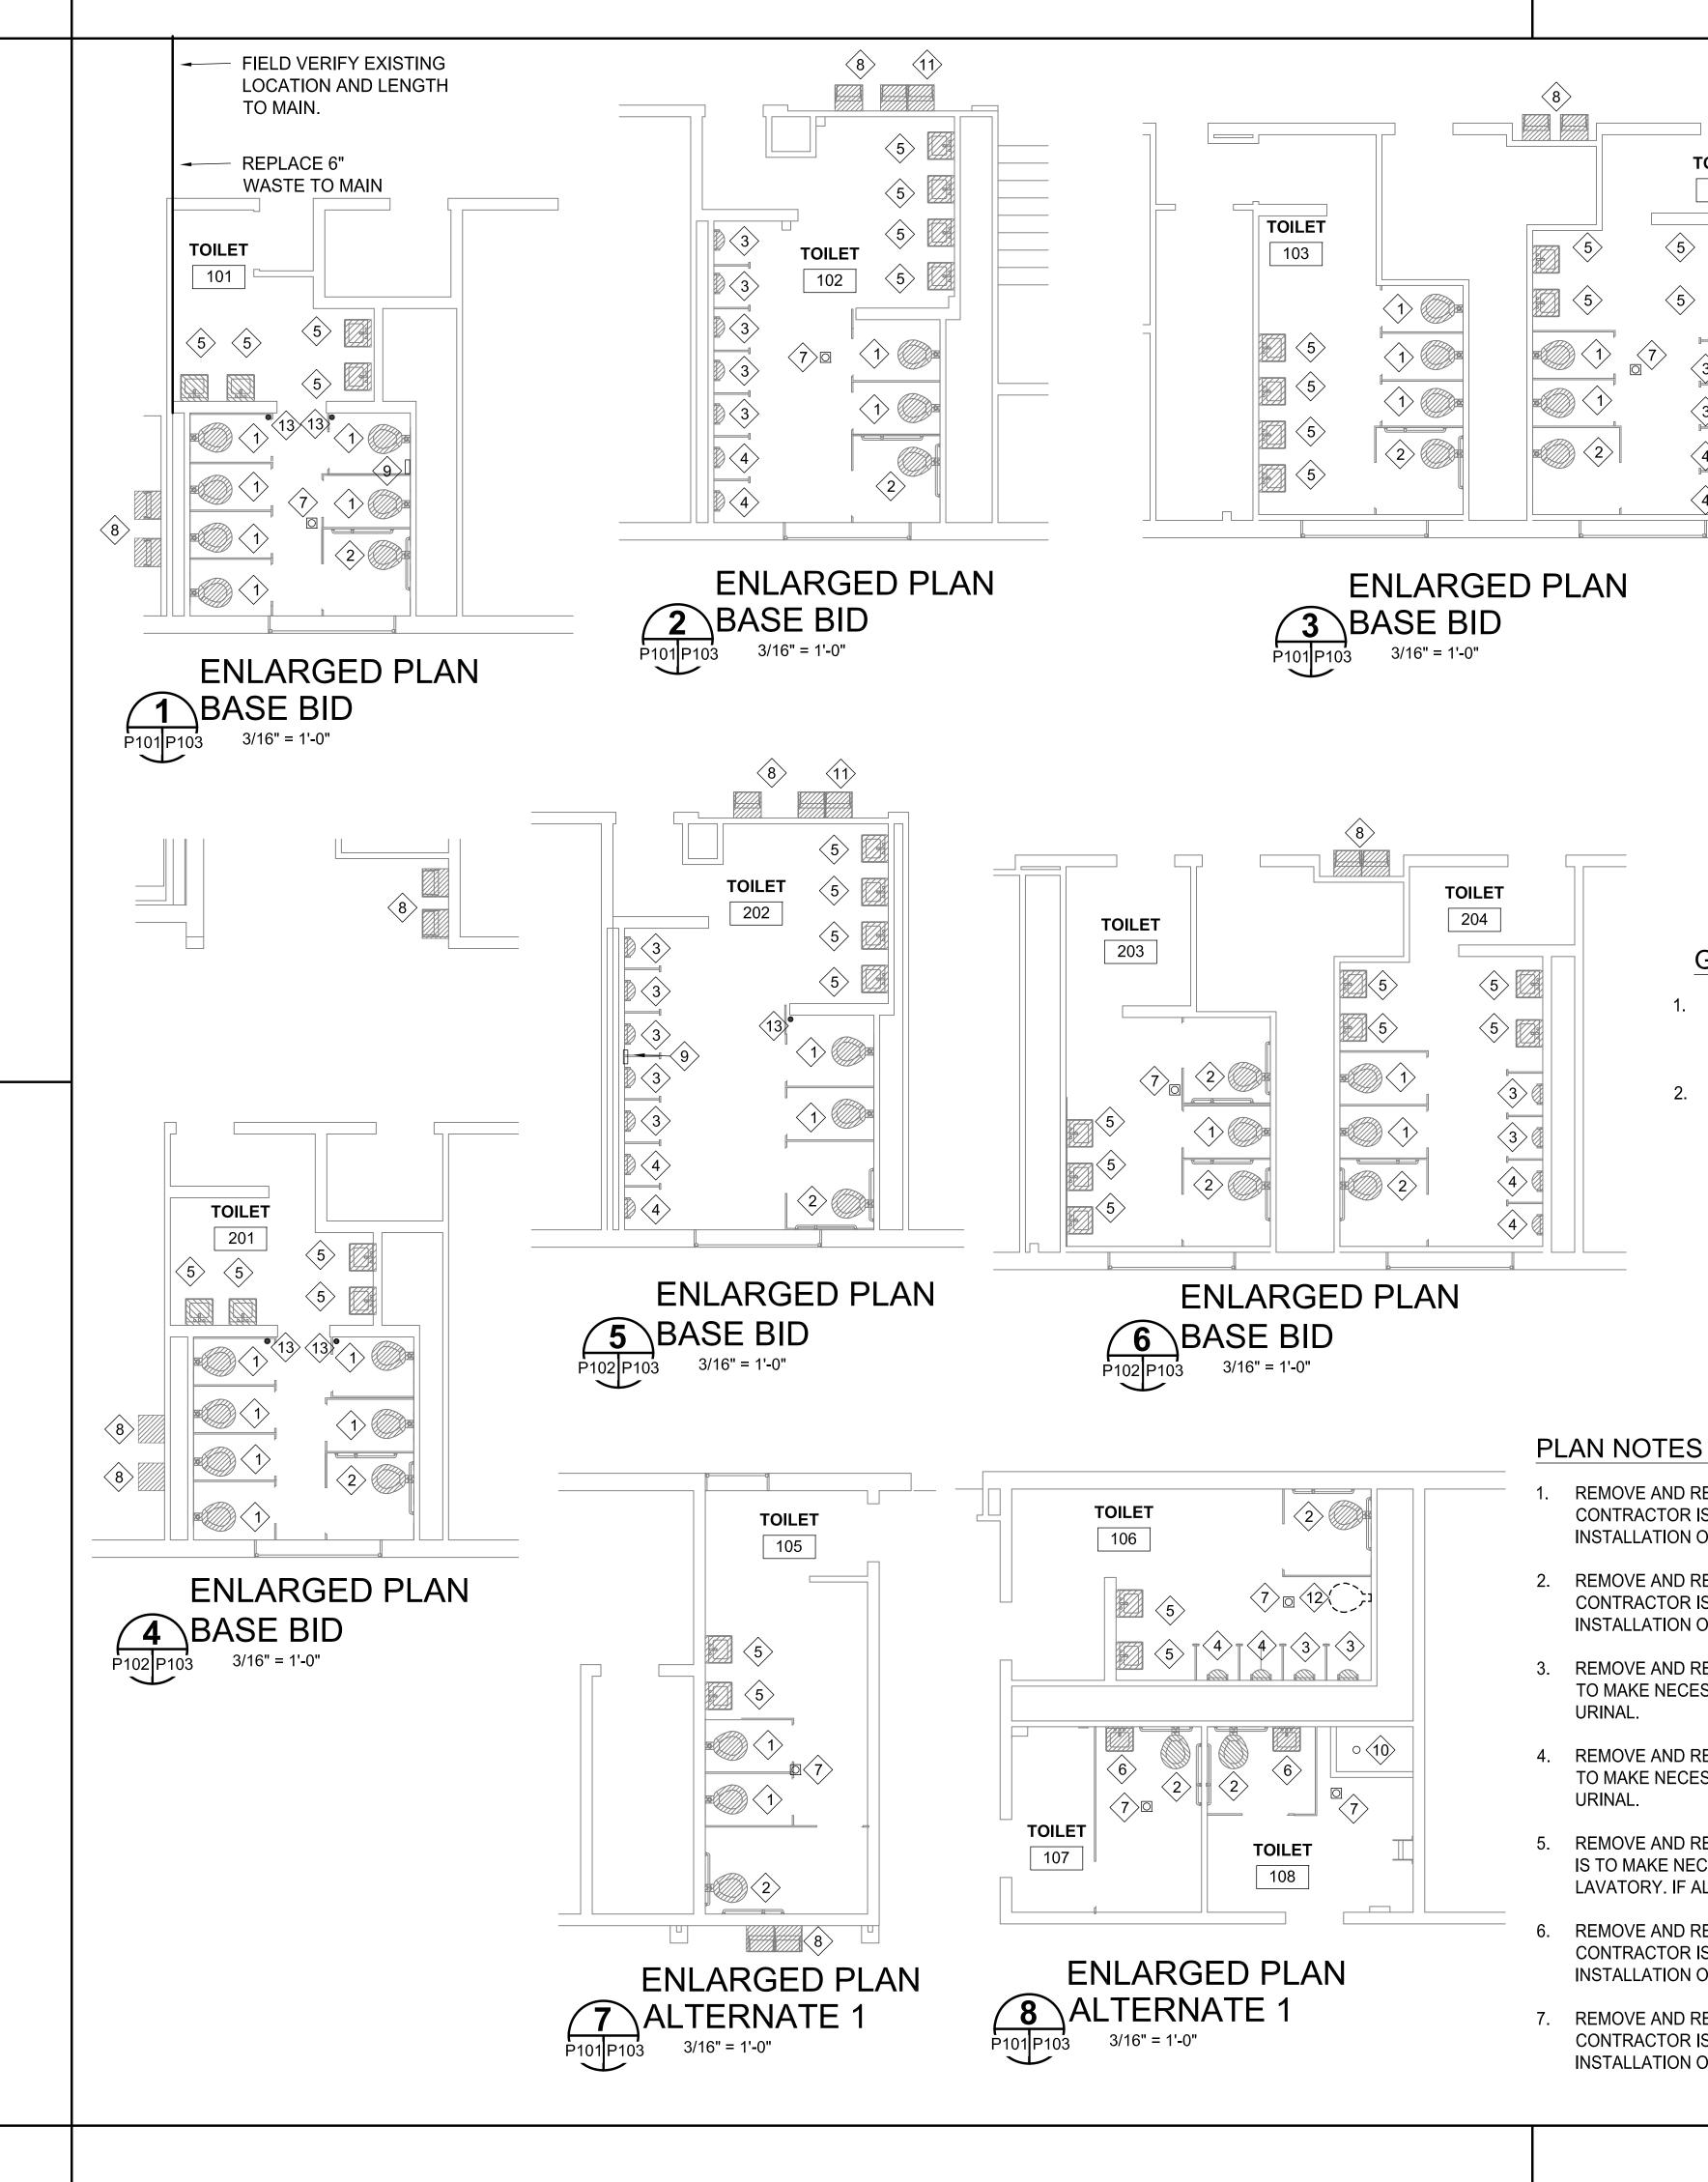


ENLARGED PLAN 11 BASE BID 3/16" = 1'-0"

GIRL LOCKER ROOM

SUMP PUMP NOTE: (#)



- DISCHARGE FROM PUMP, RISE AND RUN OUT TO EXISTING MAIN AT STREET AND CONNECT TO EXISTING SERVICES. SEE DETAIL.
- C. REMOVE EXISTING SUMP PUMP.

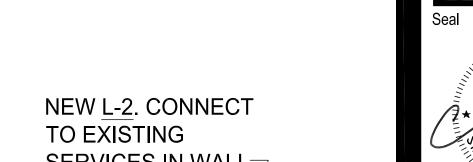

SERVICES IN WALL. CONNECT TO **HOT WATER** W/ 1/2" H.W. BOYS LOCKER ROOM

ENLARGED PLAN 10 ALTERNATE 2

GENERAL NOTES

TOILET

104

- FLUSH ALL WASTE PIPING FROM AREAS OF WORK, TO CLEAR FROM DEBRIS OR **CLOGGED AREAS TO ENSURE PROPER**
- IF ADDITIVE ALTERNATE NUMBER 4 IS TAKEN, LAVATORIES IN AREAS 1 THROUGH 6 SHALL CHANGE FROM WALL HUNG TO COUNTER MOUNTED DROP-IN. SEE NOTE 5.

REMOVE AND REPLACE EXISTING WATER CLOSET WITH WC-1. THIS

REMOVE AND REPLACE EXISTING WATER CLOSET WITH WC-2. THIS

TO MAKE NECESSARY MODIFICATIONS FOR INSTALLATION OF NEW

TO MAKE NECESSARY MODIFICATIONS FOR INSTALLATION OF NEW

REMOVE AND REPLACE EXISTING URINAL WITH U-1. THIS CONTRACTOR IS

REMOVE AND REPLACE EXISTING URINAL WITH U-2. THIS CONTRACTOR IS

REMOVE AND REPLACE EXISTING LAVATORY WITH L-2. THE CONTRACTOR

IS TO MAKE NECESSARY MODIFICATIONS FOR INSTALLATION OF NEW

REMOVE AND REPLACE EXISTING LAVATORY WITH L-2. THIS CONTRACTOR IS TO MAKE NECESSARY MODIFICATIONS FOR

REMOVE AND REPLACE EXISTING FLOOR DRAIN WITH FD-1. THIS

CONTRACTOR IS TO MAKE NECESSARY MODIFICATIONS FOR

LAVATORY. IF ALTERNATE 4 IS CHOSEN, INSTALL COUNTER MOUNT L-1.

CONTRACTOR IS TO MAKE NECESSARY MODIFICATIONS FOR

CONTRACTOR IS TO MAKE NECESSARY MODIFICATIONS FOR

INSTALLATION OF NEW WATER CLOSET.

INSTALLATION OF NEW WATER CLOSET.

INSTALLATION OF NEW LAVATORY.

INSTALLATION OF NEW FLOOR DRAIN.

URINAL.

ENLARGED PLAN 9 ALTERNATE 2

- REMOVE AND REPLACE EXISTING ELECTRIC DRINKING FOUNTAIN WITH EDF-1. THIS CONTRACTOR IS TO MAKE NECESSARY MODIFICATIONS FOR INSTALLATION OF NEW DRINKING FOUNTAIN.
- REMOVE AND REPLACE EXISTING FLOOR DRAIN WITH FD-2. THIS CONTRACTOR IS TO MAKE NECESSARY MODIFICATIONS FOR INSTALLATION OF NEW FLOOR DRAIN.
- 10. EXISTING MOP BASIN TO REMAIN. FLUSH DRAIN TO CLEAR ANY DEBRIS OR CONGESTION IN PIPING
- 11. REMOVE AND REPLACE EXISTING ELECTRIC DRINKING FOUNTAIN WITH EDF-2. THIS CONTRACTOR IS TO MAKE NECESSARY MODIFICATIONS FOR INSTALLATION OF NEW DRINKING FOUNTAIN.
- 12. REMOVE EXISTING WATER CLOSET IN THIS AREA AND CAP SERVICES AT MAINS. PATCH FLOORS AND WALLS TO MATCH EXISTING.
- 13. EXISTING PIPES THROUGH FLOOR TO BE REMOVED AND CAPPED BELOW FLOOR.
- 14. REMOVE EXISTING LAVATORY AND ASSOCIATED PIPING. CAP SERVICES IN WALL.

Phone: (601) 362-3552 Fax: (601) 366-6418

19.089.02 Engineering Resource Group 350 Edgewood Terrace Drive Jackson, MS 39206

Original Plotted Sheet Size = 24"x36"

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LARGE SCALE **PLANS TOILET RENOVATIONS**


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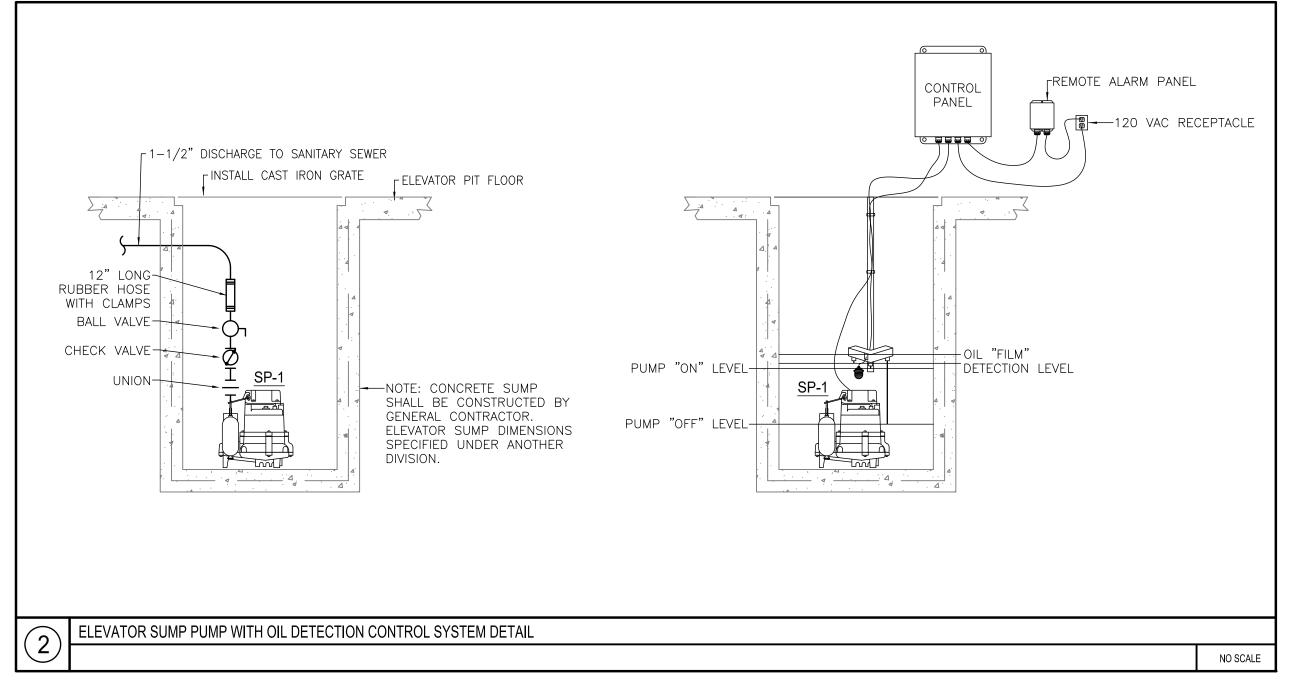
P103R

	PLUMBING FIXTURE SCHEDULE													
NAA DIK		25.44.246												
MARK	DESCRIPITION	MAKE	MODEL	SUPPLY FITTING	PIPE(S)	DRAIN	TRAP	C.W.	H.W.	WASTE	VENT	REMARKS		
WC-1	WATER CLOSET, WALL HUNG, F.V.	AMERICAN STANDARD	3351.101	ZURN Z-6200-HET				1"		4" 4"		W/ OPEN FRONT WHITE SEAT EQUAL TO BEMIS, WITH S/S BOLT, NUTS, WASHERS, & HINGES.		
WC-2	WATER CLOSET, WALL HUNG, F.V., A.D.A.	AMERICAN STANDARD	3351.101	ZURN Z-6200-HET				1"	_	4"	4"	W/ OPEN FRONT WHITE SEAT EQUAL TO BEMIS, WITH S/S BOLT, NUTS, WASHERS, & HINGES.		
U-1	URINAL, WALL HUNG F.V.	AMERICAN STANDARD	6601.012	ZURN Z-6203				3/4"		2" 2"				
U-2	URINAL, WALL HUNG F.V., A.D.A	AMERICAN STANDARD	6601.012	ZURN Z-6203				3/4"		2"	2"	MOUNT AT A.D.A. HEIGHT		
L-1	LAVATORY, OVAL, DROP-IN (ALTERNATE 4)	AMERICAN STANDARD	0475.047	ZURN Z86100-XL	ZURN Z8804-XL LRCE-PC	ZURN Z8743-PC			1/2"	2"	2"	LESS POP UP DRAIN.		
L-2	LAVATORY, WALL HUNG, A.D.A.	AMERICAN STANDARD	0356.421	ZURN Z86100-XL	ZURN Z8804-XL LRCE-PC	-XL 25141		1/2"	1/2"	2"	2"	COORDINATE ROUGH-IN WITH DRAIN ASSEMBLY. INSULATE P-TRAP AND SUPPLY PIPES W/ TRUEBRO 102G/105. LESS POP UP DRAIN.		
FD-1	FLOOR DRAIN - POLISHED BRONZE WITH TRAP PRIMER CONNECTION	ZURN	ZB-415-B-P	1			_	- -		MATCH EXIST.	MATCH EXIST.	WITH SURE SEAL		
FD-2	SCUPPER FLOOR DRAIN	ZURN	Z189						MATCH		MATCH EXIST.	WITH SURE SEAL		
EDF-1	BI-LEVEL ELECTRIC DRINKING FOUNTAIN	MURDOCK	A172408S-UBL-VR		ZURN Z8800LR		ZURN 8700B	1/2"		2"	2"			
EDF-2	SINGLE ELECTRIC DRINKING FOUNTAIN	MURDOCK	A171408S-VR	- -	ZURN Z8800LR		ZURN 8700B	1/2"		2"	2"			

MISCELLANEOUS PLUMBING POWER, CONTROL AND INTERLOCK WIRING CONNECTIONS												
TAG	DESCRIPTION	POWER	CONTROL & INTERLOCK	ELECTRICAL	REMARKS							
TAG	DESCRIPTION	WIRING	WIRING	V/Ø	REWARKS							
EDF	ELECTRIC DRINKING FOUNTAIN	DIV 26 ELECTRICAL	-	120/1								

PUMPS														
MARK	MAKE AND MODEL	DUTY	DUTY TYPE LOCAT		GPM	GPM HEAD VOLTAGE		MOTOR HP	RPM	EMERGENCY POWER	REMARKS			
SP-1	HYDROMATIC SHEF40	SUMP PIT DRAINAGE	SUMP PUMP	ELEVATOR PIT	50.0	12.0	115/1Ø	4/10	1550	NO	SEE SPECIFICATIONS			



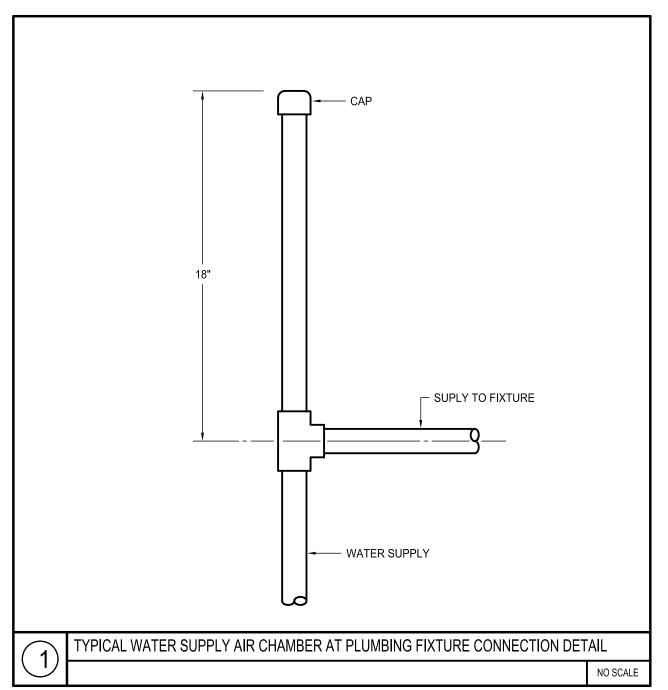




Architecture | Planning | Consult CREATE DESIGN INSPIRE | LOS E. Woodrow Wilson Ave., Jackson, MS 3

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2018 BOND PROJECT
JIM HILL HIGH SCHOOL IMPROVEMENTS
JACKSON PUBLIC SCHOOLS

iect nber: 19.00 12.02.201

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PLUMBING FIXTURE AND DETAILS FOR TOILET RENOVATIONS

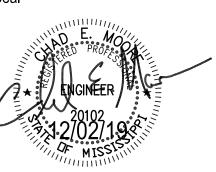
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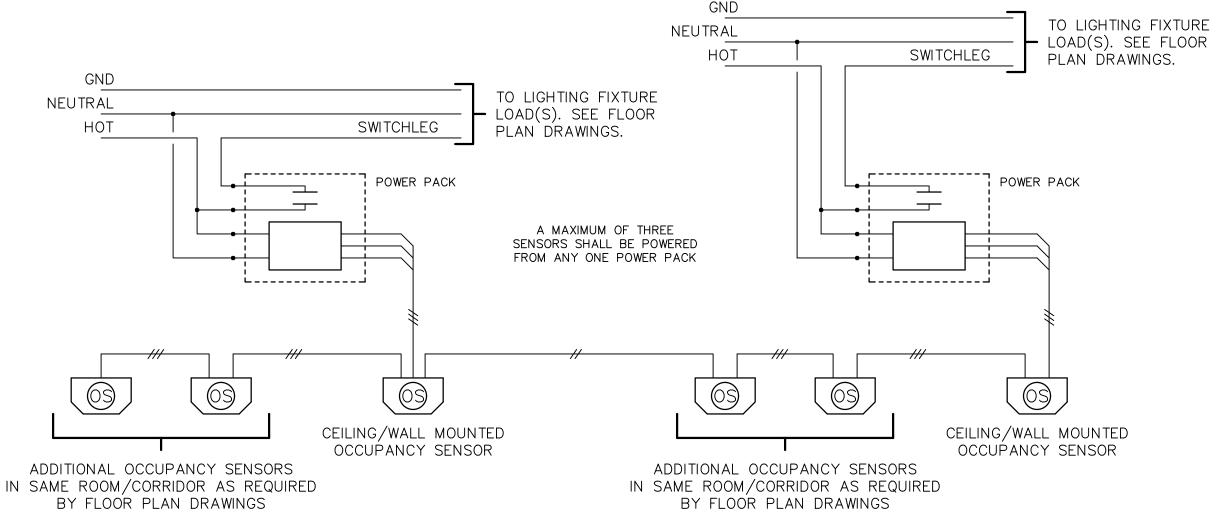
	LIGHTING FIXTURE SCHEDULE													
VOLTS	SYMBOL	WATTS DESCRIPTION MANUFACTURER CAT. NO.												
120	А	LED	LED SURFACE MOUNT, 1'X4', 5000 DELIVER LUMENS, 3500°K, 45W	KENALL LTG.	MLHA12-48-R-MW -CP-45L35K-DCC-1 120	SURFACE AT CEILING								
120	AE	LED	LED SURFACE MOUNT, 1'X4', 5000 DELIVER LUMENS, 3500°K, 45W, WITH EMERGENCY BATTERY PACK	KENALL LTG.	MLHA12-48-R-MW -CP-45L35K-DCC-1 120-PEL	SURFACE AT CEILING								
120	В	LED	LED CEILING MOUNT, 15" DIA., 3000 DELIVER LUMENS, 3500°K, 29W.	KENALL LTG.	RHR15-W-PP- 25L35K-DV	CEILING								

NOTE: PROVIDE UNISTRUT CHANNEL AS REQUIRED FOR AREAS WITH CEILING PANELS TO MOUNT TO STRUCTURE ABOVE.

	ELECTRICAL SERVICE & DISTRIBUTION
()	SWITCH, UNFUSED SAFETY DISCONNECT, AMPERE RATING, NUMBER OF POLES, PROPER VOLTAGE RATING
SU	FOR BRANCH CIRCUIT, SURFACE MOUNT C.L. UP 54" A.F.F. UNLESS INDICATED OTHERWISE.
SR	SWITCH, UNFUSED SAFETY DISCONNECT, NEMA 3R RATED, AMPERE RATING, NUMBER OF POLES, PROPER VOLTAGE RATING FOR BRANCH CIRCUIT, MOUNT C.L. UP 54" A.F.F. UNLESS INDICATED OTHERWISE.
SF	SWITCH, FUSED SAFETY DISCONNECT, AMPERE RATING, NUMBER OF POLES, PROPER VOLTAGE RATING FOR BRANCH CIRCUIT, SURFACE MOUNT C.L. UP 54" A.F.F. UNLESS INDICATED OTHERWISE.
SFR	SWITCH, FUSED SAFETY DISCONNECT, NEMA 3R RATED, AMPERE RATING, NUMBER OF POLES, PROPER VOLTAGE RATING FOR BRANCH CIRCUIT, MOUNT C.L. UP 54" A.F.F. UNLESS INDICATED OTHERWISE.
	<u>ABBREVIATIONS</u>
A.A.C.	ADJACENT TO ANY SYMBOL DENOTES DEVICE/OUTLET INSTALLED ABOVE ACCESSIBLE CEILING.
A.F.F.	DENOTES "ABOVE THE FINISHED FLOOR".
B.F.G.	DENOTES "BELOW THE FINISHED GRADE".
EDF	ADJACENT TO ANY OUTLET SYMBOL DENOTES DEVICE/OUTLET IS FOR ELECTRIC DRINKING FOUNTAIN, VERIFY MOUNTING HEIGHT & LOCATION FOR CONCEALMENT BEHIND EQUIPMENT.
TV	ADJACENT TO ANY OUTLET SYMBOL DENOTES DEVICE/OUTLET IS FOR WALL MOUNTED TELEVISION, VERIFY MOUNTING HEIGHT & LOCATION FOR CONCEALMENT BEHIND EQUIPMENT.
PROJ	ADJACENT TO ANY OUTLET SYMBOL DENOTES DEVICE/OUTLET IS FOR PROJECTOR, MOUNT OUTLET ADJACENT TO EQUIPMENT AT CEILING/STRUCTURE, VERIFY MOUNTING LOCATION PRIOR TO ROUGH—IN.
EX	ADJACENT TO ANY SYMBOL DENOTES DEVICE/OUTLET IS EXISTING.
	FIRE DETECTION & ALARM SYS.
Ø	FIRE ALARM SYSTEM VISUAL ALARM DEVICE, MOUNT C.L. UP 80" A.F.F. OR 6" BELOW THE FINISHED CEILING WHICHEVER IS LOWER, STROBE CANDELA RATING — MINIMUM 15/75 WHERE NOT LISTED.
∇	FIRE ALARM SYSTEM AUDIBLE & VISUAL ALARM DEVICE, MOUNT C.L. UP 80" A.F.F. OR 6" BELOW THE FINISHED CEILING WHICHEVER IS LOWER, STROBE CANDELA RATING — MINIMUM 15/75 WHERE NOT LISTED.
(<u>1)-FA-3/4</u> "	FIRE ALARM SYSTEM RACEWAY SYSTEM CONDUIT & CABLING, ROUTE CONCEALED ABOVE CEILING OR IN WALL NUMBER OF CONDUITS, SIZE OF CONDUIT(S) AS INDICATED OR AS REQUIRED FOR SUPPLIED CABLING, NUMBER & TYPE OF WIRING AS REQUIRED FOR SYSTEM & INSTALLED ENVIRONMENT.
2-FA-3/4"	FIRE ALARM SYSTEM HOMERUN RACEWAY SYSTEM CONDUIT & CABLING, ROUTE CONCEALED ABOVE CEILING OR IN WALL, NUMBER OF CONDUITS, SIZE OF CONDUIT(S) AS INDICATED OR AS REQUIRED FOR SUPPLIED CABLING, NUMBER & TYPE OF WIRING AS REQUIRED FOR SYSTEM & INSTALLED ENVIRONMENT. ROUTE TO FIRE ALARM SYSTEM CONTROL PANEL UNLESS OTHERWISE INDICATED.
	ELECTRICAL GEAR
	LIGHTING AND SMALL POWER PANEL, SURFACE MOUNTING, 250 VOLT SYSTEM.





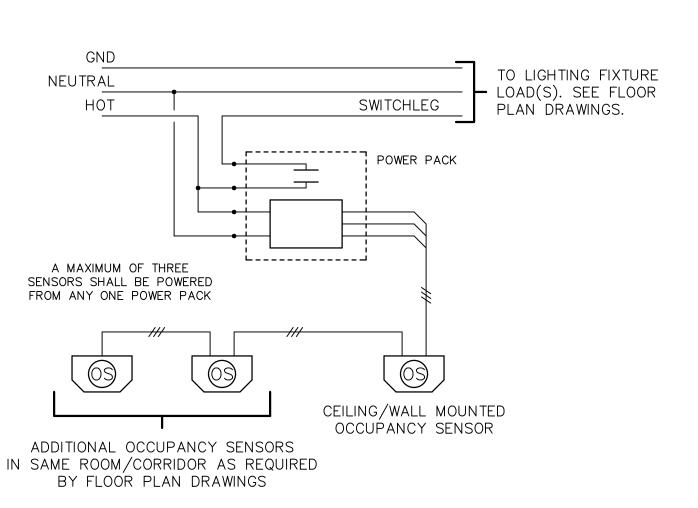

MULTIPLE BRANCH CIRCUITS & MULTIPLE SENSORS

ROOM OCCUPANCY SENSOR(S) SCHEMATIC WIRING DIAGRAMS

TYPICAL

NO SCALE

ELECTRICAL SYMBOLS LEGEND

ELECTRICAL SYMBOLS LEGEND

RACEWAYS & BOXES BRANCH CIRCUIT (CONDUIT AND WIRING) CONCEALED ABOVE CEILING OR IN WALL, NUMBER OF CONDUCTORS. (— /) INDICATES GREEN GROUNDING CONDUCTOR SIZED PER BRANCH CIRCUIT UNLESS OTHERWISE NOTED. BRANCH CIRCUIT (CONDUIT AND WIRING) EXPOSED IN FLEXIBLE METALLIC CONDUIT, NUMBER CONDUCTORS. BRANCH CIRCUIT (CONDUIT AND WIRING) EXPOSED IN LIQUID-TIGHT FLEXIBLE METALLIC CONDUIT WITH PROPER LIQUID-TIGHT FITTINGS, NUMBER OF CONDUCTORS. BRANCH CIRCUIT(S) HOMERUN, PANEL & CIRCUIT DESIGNATIONS, ROUTE CONCEALED, NUMBER OF CONDUCTORS, MINIMUM 3/4" CONDUIT UNLESS NOTED OTHERWISE, ALL HOMERUNS GREATER THAN 50 FEET IN LENGTH SHALL USE #10 AWG CONDUCTORS MINIMUM. <u>LUMINAIRES</u> LIGHTING LUMINAIRE OUTLET WITH LUMINAIRE PER LIGHTING LUMINAIRE SCHEDULE, LUMINAIRE SYMBOL (#), BRANCH CIRCUIT DESIGNATION(S) (*), MOUNTING PER THE LUMINAIRE SCHEDULE. SURFACE LUMINAIRE OUTLET WITH LUMINAIRE PER LIGHTING LUMINAIRE SCHEDULE, LUMINAIRE SYMBOL (#), BRANCH CIRCUIT DESIGNATION(S) (*), SURFACE MOUNT PER THE LUMINAIRE SCHEDULE. RECESSED TROFFER LUMINAIRE WITH LUMINAIRE PER LIGHTING LUMINAIRE SCHEDULE, LUMINAIRE SYMBOL (#), BRANCH CIRCUIT DESIGNATION(S) (*), RECESS MOUNT PER THE LUMINAIRE SCHEDULE. HATCH LINES THRU ANY LIGHTING LUMINAIRE SYMBOL DENOTES LIGHTING LUMINAIRE IS EQUIPPED WITH A EMERGENCY BATTERY PACK.

SWITCHES & LIGHTING CONTROL DEVICES

TOGGLE SWITCH WITH BOX & PLATE, 20A1P, 120/277V, FLUSH MOUNT C.L. UP 48" A.F.F. UNLESS NOTED OTHERWISE.

MANUAL MOTOR SWITCH WITH BOX AND PLATE, 20A1P, 120/277V, FLUSH MOUNT C.L. UP 48" A.F.F. UNLESS NOTED OTHERWISE.

SWITCH WITH BOX & PLATE, OCCUPANCY SENSOR TYPE, PASSIVE INFRARED, MOUNT C.L. UP 48" A.F.F. UNLESS NOTED OTHERWISE.

OCCUPANCY SENSOR. SEE DETAIL THIS SHEET. MT DENOTES MULTI-TECHNOLOGY TYPE.

RECEPTACLES & POWER OUTLETS

 S_{os}

DUPLEX GROUNDING RECEPTACLE WITH BOX, PLATE & BRANCH CIRCUIT, 120 VOLTS, NEMA 5-20R, MOUNT C.L. UP 18" A.F.F. UNLESS OTHERWISE INDICATED, CIRCUIT DESIGNATION.

DUPLEX GROUNDING RECEPTACLE WITH BOX, PLATE & BRANCH CIRCUIT, 120 VOLTS, NEMA 5-20R, MOUNT C.L. UP 4" ABOVE COUNTER/BACKSPLASH UNLESS OTHERWISE INDICATED, CIRCUIT DESIGNATIONS.

DUPLEX GROUNDING RECEPTACLE WITH BOX, PLATE & BRANCH CIRCUIT, G.F.I. TYPE, 120 VOLTS, NEMA 5-20R, MOUNT C.L. UP 18" A.F.F. UNLESS OTHERWISE INDICATED, CIRCUIT DESIGNATION.

DUPLEX GROUNDING RECEPTACLE WITH BOX, PLATE & BRANCH CIRCUIT, G.F.I. TYPE, 120 VOLTS, NEMA 5-20R, MOUNT C.L. UP 4" ABOVE COUNTER/BACKSPLASH WHERE PRESENT OR C.L. UP 48" A.F.F. UNLESS OTHERWISE INDICATED, CIRCUIT DESIGNATION.

GENERAL BRANCH CIRCUIT NOTES: (APPLICABLE TO ALL SHEETS.)

LIGHTING & POWER BRANCH CIRCUITS (CONDUITS & CONDUCTORS) ALTHOUGH NOT SHOWN ON THE DRAWINGS SHALL BE PROVIDED & CONNECTED AS REQUIRED FOR PROPER OPERATION OF THE

2. ALL BRANCH CIRCUITS SHALL BE ROUTED IN CONDUIT PER THE SPECIFICATIONS. ALL BRANCH CIRCUITS SHALL HAVE DEDICATED NEUTRAL CONDUCTOR. ALL BRANCH CIRCUITS SHALL HAVE A

3. ALL 120V BRANCH CIRCUITS IN EXCESS OF 50 FEET IN LENGTH SHALL UTILIZE #10 CONDUCTORS FOR PHASE, NEUTRAL & GROUND CONDUCTORS. ALL 277V BRANCH CIRCUITS IN EXCESS OF 100 FEET IN LENGTH SHALL UTILIZE #10 CONDUCTORS FOR PHASE, NEUTRAL & GROUND CONDUCTORS.

4. WALL SWITCH(ES) AND/OR OCCUPANCY SENSOR(S) WHERE INDICATED IN A ROOM/SPACE SHALL BE PROVIDED & CONNECTED TO CONTROL ALL LUMINAIRES IN THAT ROOM/SPACE UNLESS INDICATED OTHERWISE. 3-WAY & 4-WAY SWITCHES SHALL BE PROVIDED & CONNECTED FOR

WHERE WALL SWITCHES ARE INDICATED IN THE SAME ROOM/SPACE WITH OCCUPANCY SENSORS, THE WALL SWITCHES SHALL BE CONNECTED BETWEEN THE OCCUPANCY SENSOR & THE LIGHTING

WHERE EMERGENCY BATTERY PACKS ARE INDICATED OR SPECIFIED THEY SHALL BE PROPERLY CONNECTED PER THE MANUFACTURER'S RECOMMENDATIONS TO A NON-SWITCHED LEG OF THE

BRANCH CIRCUIT HOMERUNS & JUNCTION BOXES SHOWN ON THE FLOOR PLAN DRAWINGS ARE FOR INDICATING BRANCH CIRCUITS SHARING A COMMON HOMERUN RACEWAY & FOR GENERAL LOCATION OF THE HOMERUN. THE ACTUAL JUNCTION BOX & HOMERUN ORIGINATION LOCATION SHALL BE FIELD DETERMINED BASE ON THE FINISHES OF THE AREA IN WHICH LOCATED TO INSURE

8. LIGHTING LUMINAIRES INDICATED TO BE CONTROLLED BY 0-10V DIMMING SHALL HAVE PROPER PURPLE/GRAY CONTROL WIRES PROVIDED & ROUTED IN THE SAME CONDUIT AS THE POWER

INDICATED LIGHTING LUMINAIRES, LIGHTING CONTROL SYSTEM, DEVICES, ETC..

PROPERLY SIZED EQUIPMENT GROUNDING CONDUCTOR.


PROPER OPERATION & SHALL CONTROL ALL LUMINAIRES IN THE ASSOCIATED ROOM/SPACE UNLESS OTHERWISE INDICATED.

BRANCH CIRCUIT INDICATED FOR THE ASSOCIATED LIGHTING LUMINAIRE.

INSTALLATION COMPLIES WITH THE ACCESSIBILITY REQUIREMENTS OF THE NEC.

WIRING. CONTROL WIRING SHALL BE MINIMUM #14 AWG & RATED FOR 600V.



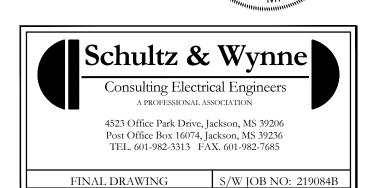

Original Plotted Sheet Size = 24"x36"


Greg L. Durrell, AIA

SCH00I

JIM HILL 2018 BOND PROJECT
TOILET IMPROVEMENT
JACKSON PUBLIC SCHO

ELECTRICAL SYMBOLS, LIGHTING **SCHEDULE**

Sheet Number . of

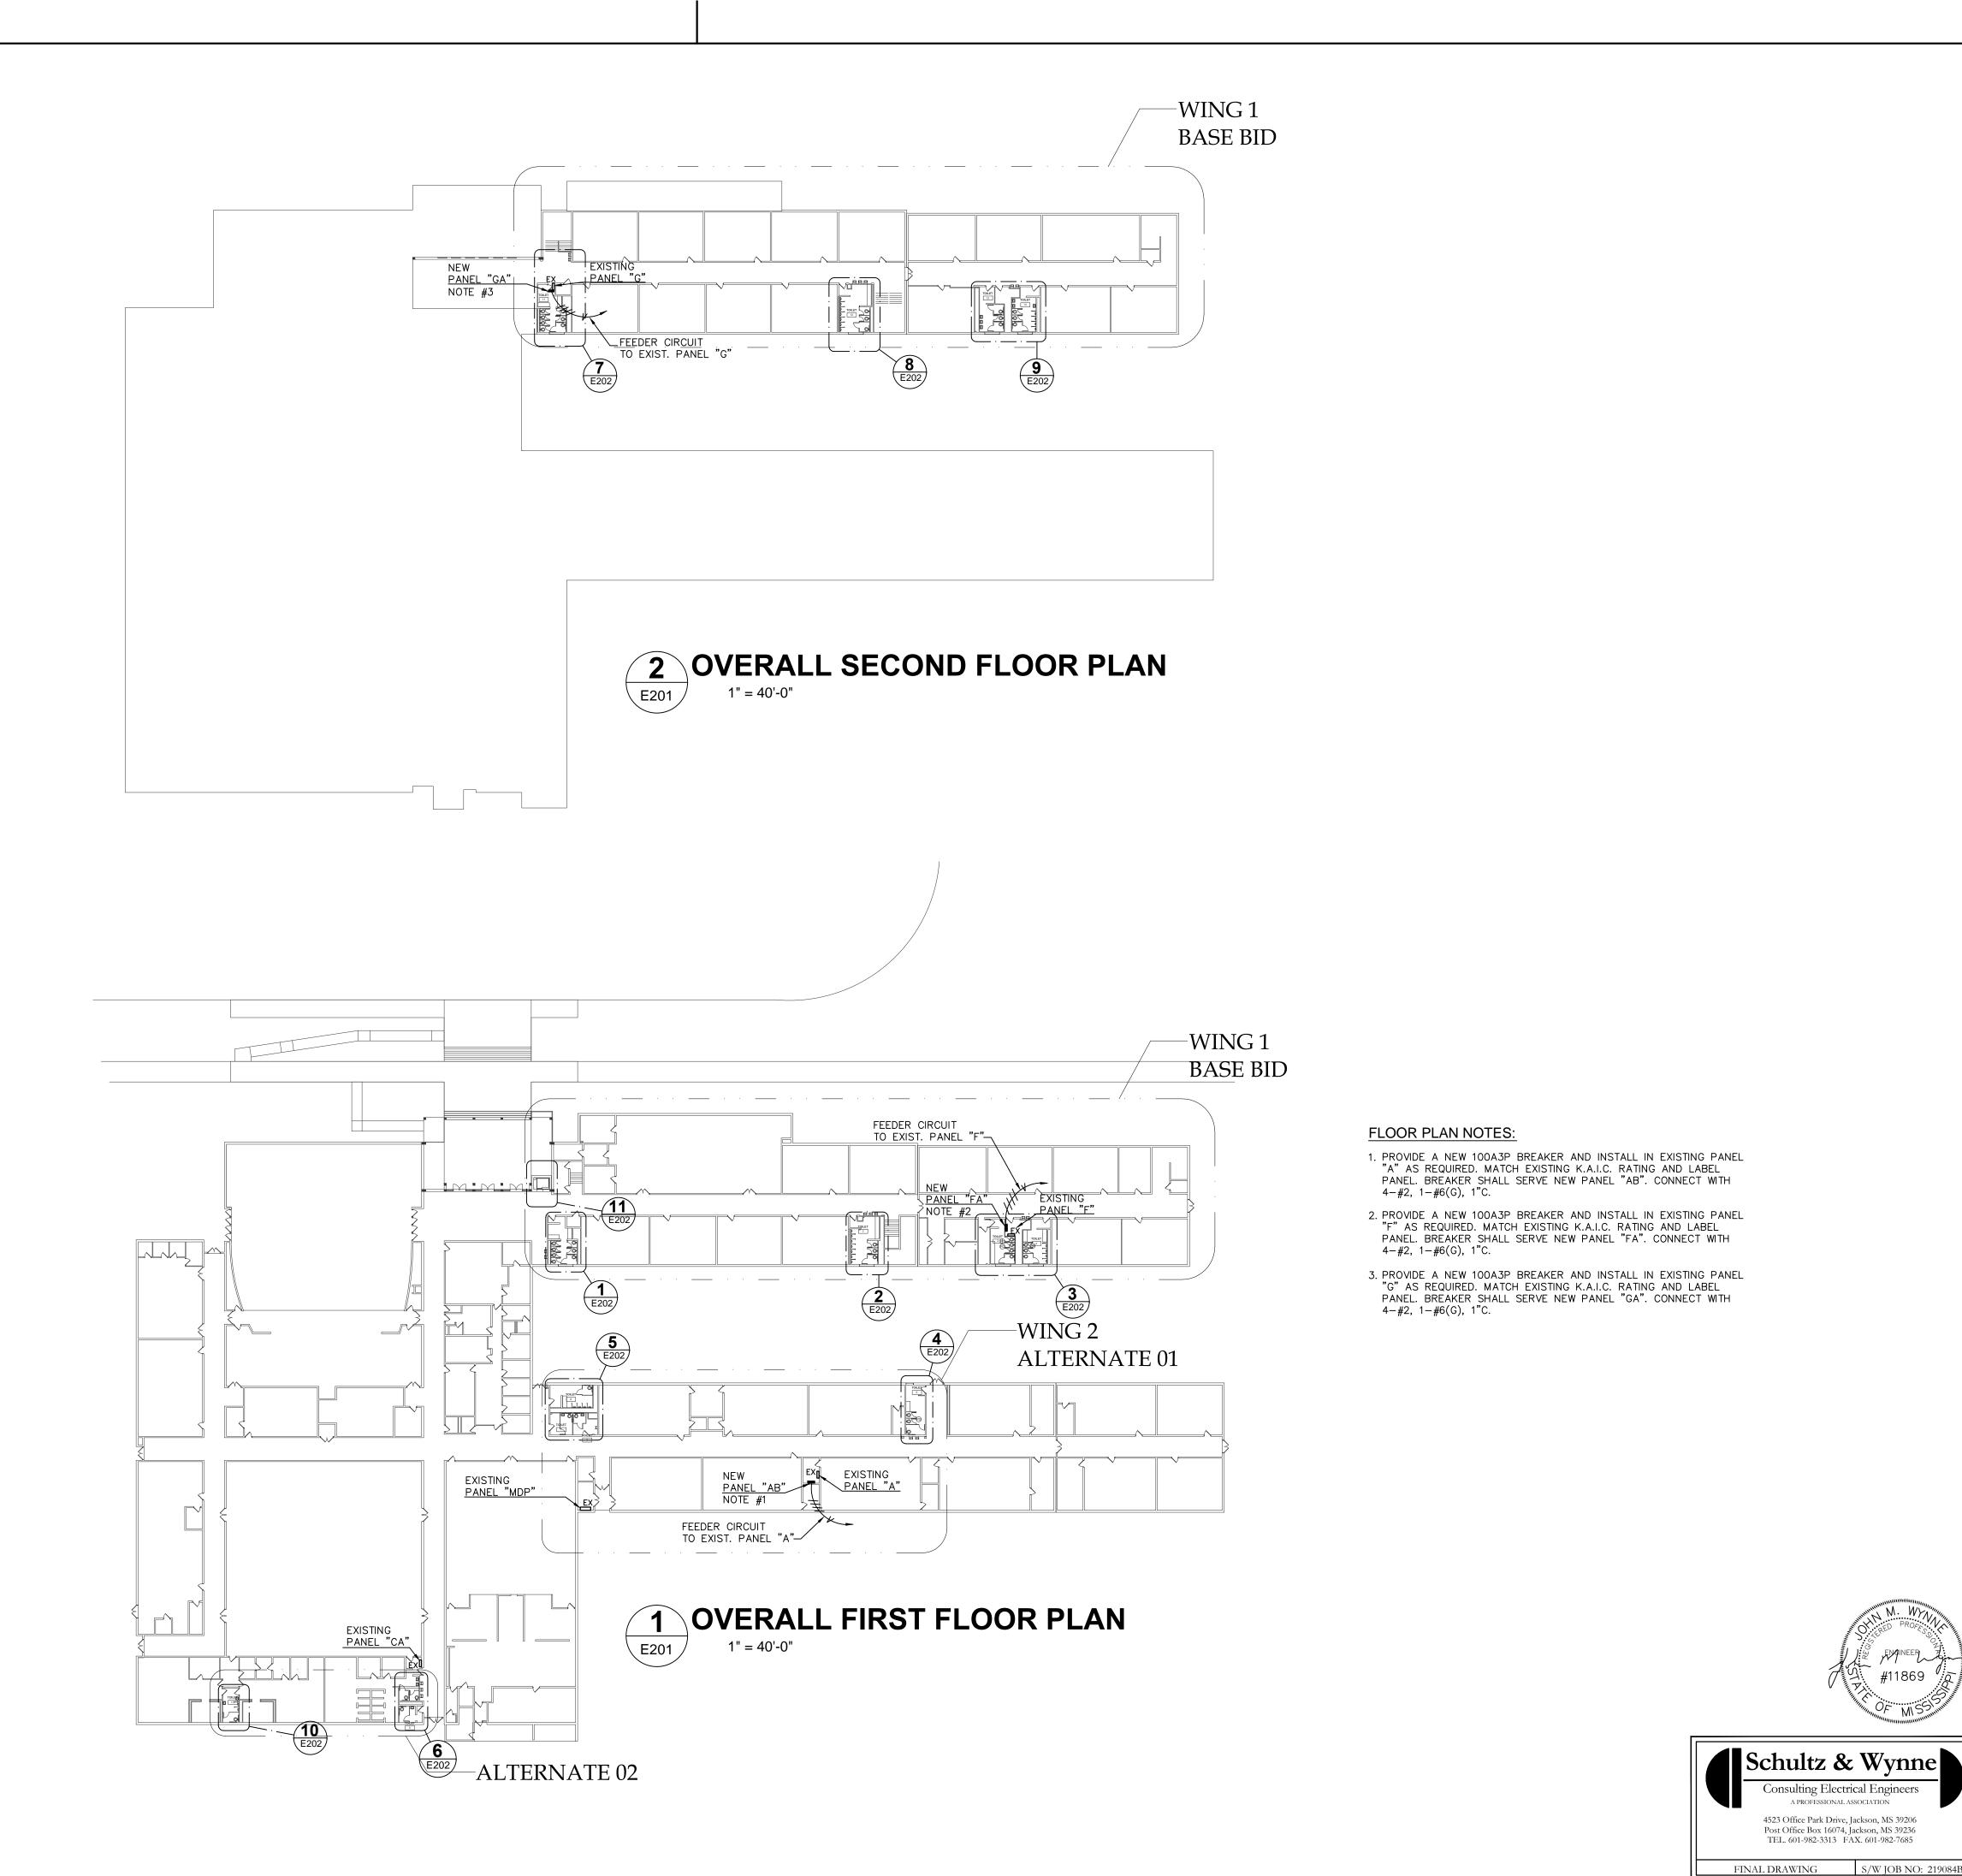

LL DESIGN GROUP, PL ture | Planning | Consulting DESIGN • INSPIRE • LEA W Wilson Ave., Jackson, MS 392

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Seal

'S FOR JIM HILL HIGH SCHOOL OOLS

TOILET IMPROVEMENTS
JACKSON PUBLIC SCHO

Date: _____ 12.02.2019
Drawn by: ____ DWV
Checked by: ____ J.M.W
Revisions

1 1/15/2020

Sheet Title


OVERALL FIRST AND SECOND FLOOR LOCATION PLANS


Sheet Number . of

E201R

FLOOR PLAN NOTES:


- 1. ALL EXISTING LIGHTING FIXTURES SHALL BE DISCONNECTED, REMOVED AND RETURNED TO OWNER PER THE ARCHITECTS DEMOLITION DIRECTIVE. NEW LIGHTING FIXTURES SHALL BE INSTALLED AND CONNECTED TO EXISTING LIGHTING CIRCUIT SERVING THIS ROOM/AREA. REWORK EXISTING BRANCH CIRCUITRY AS REQUIRED FOR NEW OCCUPANCY SENSORS AND EMERGENCY BATTERY PACKS.
- RECEPTACLES SERVING THE EXISTING FOUNTAINS. MAINTAIN ANY PASS—THRU CIRCUITRY AS REQUIRED. PROVIDE A NEW GFI TYPE RECEPTACLE AT EACH NEW FOUNTAIN LOCATION AND CONNECT TO NEW CIRCUIT AS INDICATED.

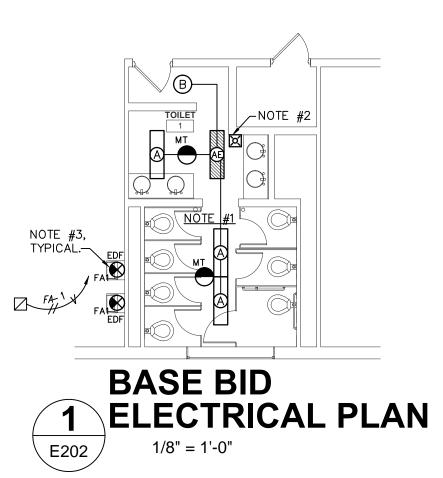

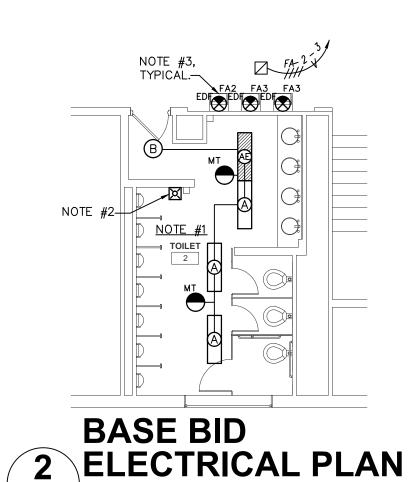


1/8" = 1'-0"


E202

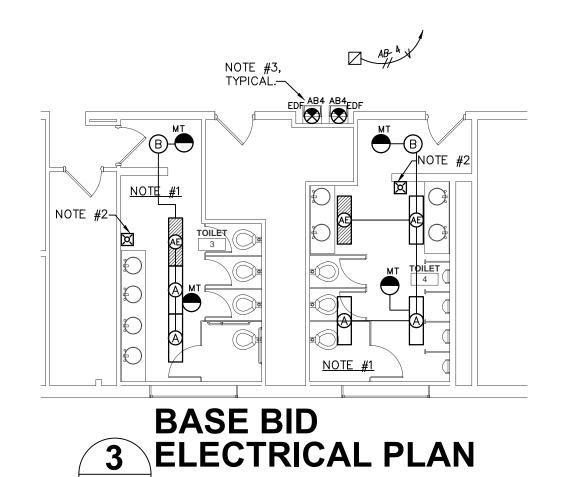


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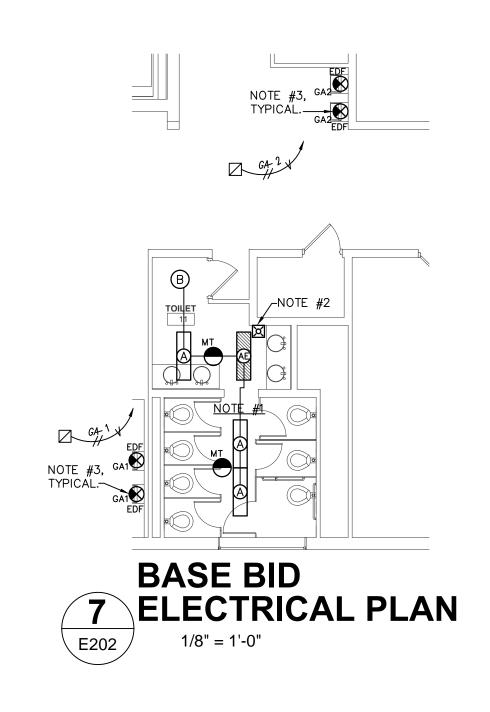
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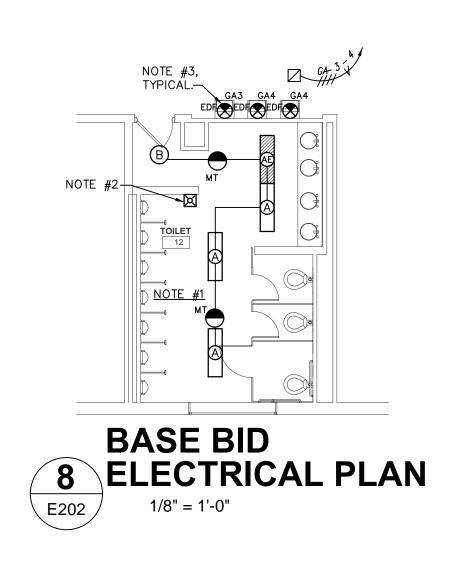





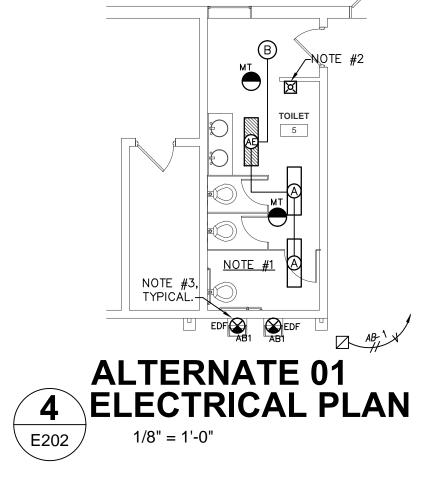


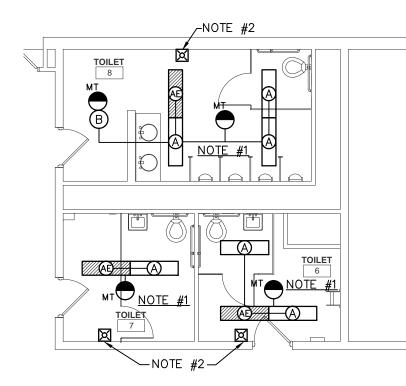




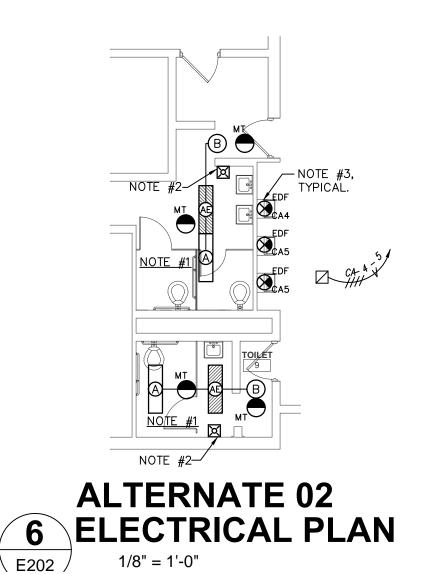


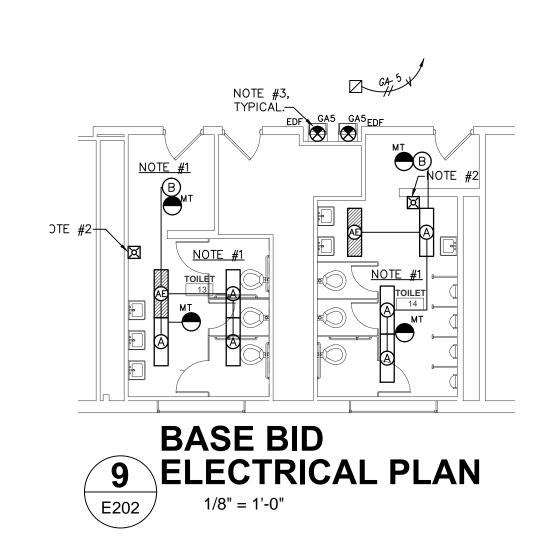

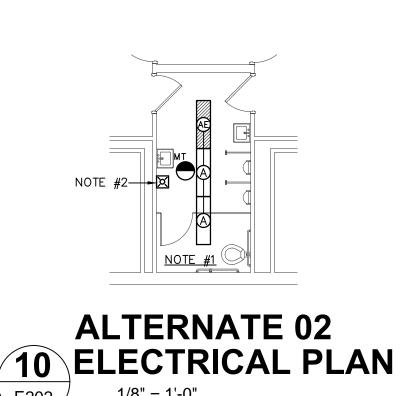

CIRCUIT SCHEDULE				CIRCUIT SCHEDULE					CIRCUIT SCHEDULE					CIRCUIT SCHEDULE					
PANEL	CIRCUIT	POLES	AMPS	REMARKS	PANEL	CIRCUIT	POLES	AMPS	REMARKS	PANEL	CIRCUIT	POLES	AMPS	REMARKS	PANEL	CIRCUIT	POLES	AMPS	REMARKS
CA (EXISTING)	1-2 3 4-5	3 1 1	20 20 20	VOLTAGE: 208Y/120 W/GND: 3PH. 4W. M.L.O.: 225A. MOUNTING: SURFACE K.A.I.C.: 22	AB	1	1	20	VOLTAGE: 208Y/120 W/GND: 3PH. 4W. M.L.O.: 125A. MOUNTING: SURFACE K.A.I.C.: 22	FA	1-4	1	20	VOLTAGE: 208Y/120 W/GND: 3PH. 4W. M.L.O.: 125A. MOUNTING: SURFACE K.A.I.C.: 22	GA	1-5	1	20	VOLTAGE: 208Y/120 W/GND: 3PH. 4W. M.L.O.: 125A. MOUNTING: SURFACE K.A.I.C.: 22
SPARES SPACES TOTAL	(8) (25)	1 1 42	20 –	CIRCUITS 1 THRU 3 ARE EXISTING.	SPARES SPACES TOTAL	(8) (21)	1 1 30	20 –		SPARES SPACES TOTAL	(8) (18)	1 1 30	20 —		SPARES SPACES TOTAL	(8) (17)	1 1 30	20 -	

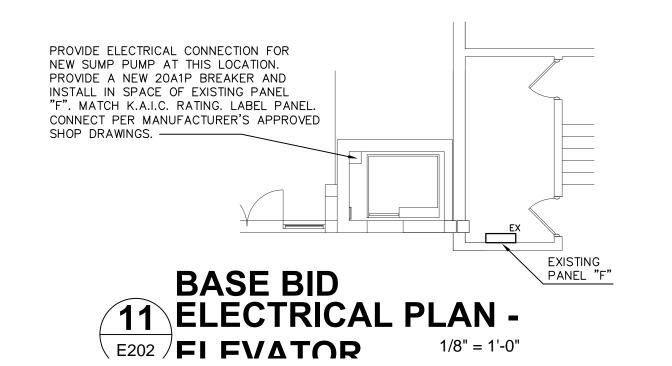

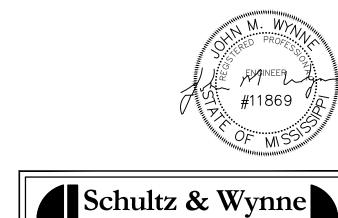

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ELECTRICAL FLOOR PLANS

Sheet Number